Development Review Committee Agenda

Chehalis Building and Planning Department
March 6, 2024, at 9 A.M.
Meeting Location: Chehalis Airport Conference Room

9:00 AM UGA-ST-23-0006; 0 Kennicott Road

Applicant proposes to install a pad for equipment of PSE, a natural gas regulator rebuild at Lewis County Parcel 010800001000 zoned R-1 – Single-Family, Low Density in the Urban Growth Area.

9:30 AM AC-24-008; 1950 Kresky Ave NE

Applicant proposes the expansion of an existing mobile home park to add 17 new spaces. Lewis County Parcel 021647004003 zoned CG – Commercial General on approximately 5.83 acres.

10:00 AM AC-24-007; 841 NW Prindle

Applicant proposes to construct a 97-room extended stay hotel directly west of Holiday Inn Express Hotel. Lewis County Parcel 005780005000 zoned CG- Commercial General on 0.97 acres.

11:00 Interdepartmental staff meeting.

Join Zoom Meeting

https://us06web.zoom.us/j/83910241095?pwd=dUI1Ym0rTkt6SHZCZjkxUTRHVDBUUT09

Directions to Development Review Committee


Chehalis Airport Conference Room




Coordinates:

(46.672787, -122.984924)

or 46° 40' 22.0332" N 122° 59' 5.7264" W

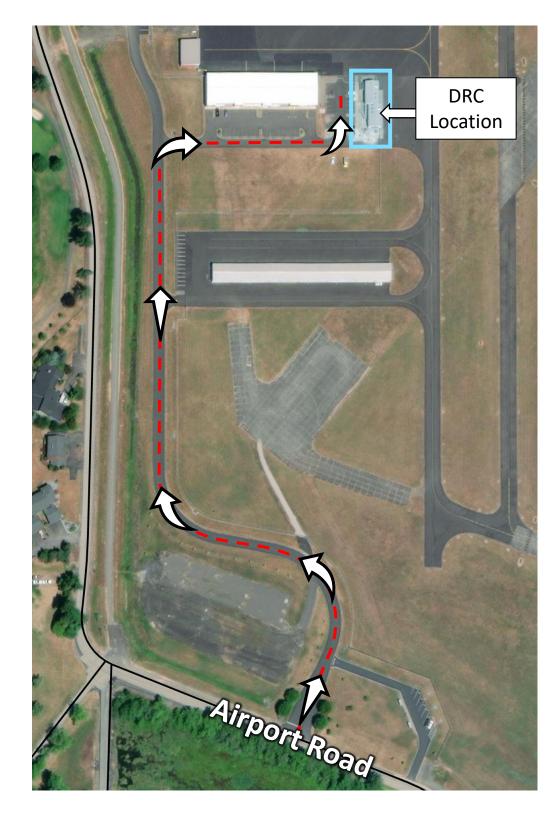

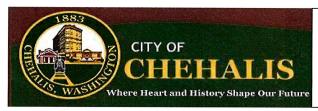

Return your permit application to Community Development Department

1321 S Market Blvd. Chehalis, WA 98532

(360) 345-2229

www.ci.chehalis.wa.us email: comdev@ci.chehalis.wa.us

Job site address:	No Address	Parcel #:	010800001000
Applicant/Contact Perso	on	-	
Name:	Trevor Lessard on behalf of	of PSE	
Mailing address:	1140 N 94th St.		
City, State, and Zip:	Seattle, WA 98103		
Phone #:	206-390-9660	Email: (require	ed) Trevor.Lessard@pse.com
	e same as the applicant: Yes 🗹	No□ If yes, you m	ay skip the property owner section
Property Owner			
Name:	Puget Sound Energy		
Mailing address:	355 110th Ave NE		
City, State, and Zip:	Bellevue, WA 98004		
Contractor/Engineer/Su		Contractor's L	&I #:
Contact Name:	Doug Mason		1 1 1 1 1 1 1 1 1 1 1 1 1 1 1 1 1 1 1 1
Company/Firm Name:	Infrasource Services, LLC	4 27	
Mailing address:	14103 Stewart Rd		
City, State, and Zip:	Sumner, WA 98390-9641		
Phone #:		Email: (require	ed) Doug.Mason@infrasourceinc.com
Project Description: (Crea	ite a project narrative on a separate page	e if there is not enou	gh room to completely describe your project below.)
See attached project na			
Current market value of			
(Fair market labor and materio	(als) \$900,000		
Only the plan(s) submitted	will be reviewed for compliance with	applicable codes.	By signing below, you grant permission for any
City of Chehalis employee t	he right to access and remain on the	property for the p	urpose of review and approval of this proposal
and to conduct inspections	related to this proposal.		
Signature: Travor	Lessard		Date: 11/14/2023
Print Name: Trevor Le	ssard		
Office use only			
Received by:		Date Received	:
Parcel #:		_ , 5	
Permit #:		_	
Zoning:			after the state of the state of
Flood Zone: yes no	Zone Classification:	_	

Puget Sound Energy

P.O. Box 97034 Bellevue, WA 98009-9734

PSE.com

November 07, 2023

City of Chehalis
Department of Community Development
1321 S Market Boulevard
Chehalis. WA 98532

RE: PSE Kennicott Road Natural Gas District Regulator Rebuild – Building Permit

To Whom It May Concern:

PSE is seeking a *building permit* for our proposal to rebuild and expand the natural gas district regulator located at the corner of Kennicott Road and Hosanna Lane, just east of the City of Chehalis, within the city's urban growth area. The district regulator does not have an assigned street address, however its parcel number is 010800001000. PSE is proposing this project to bring the site up to modern PSE standards for continued safety and reliability of natural gas delivery to local customers.


The scope of work for this project includes removing nine trees and clearing and grading about 2,000 square feet of the southwestern portion of the property. Grading is necessary to provide a flat pad for the equipment and access, while tree removals and clearing is required for equipment protection or impacts from the grading requirements. Trees along the eastern property line will remain as a buffer for the next door residence. PSE will remove the old, existing underground equipment and install new underground equipment. Underground equipment will be spaced per PSE standards to ensure proper protections for the system. The only above ground items of note include small instruments like meters and gauges for monitoring the underground systems.


The project does occur and the base of a hillside and there are slopes on the property. PSE has had a geo-tech report completed, attached in this application, for any concerns with mapped, local landslide zones. From this study, it is noted that there is no risk of landslide concerns for this property, or the potential for this property to create a landslide. Beyond this, there are no other critical areas or other environmental hazards or concerns for this property.


If you have any questions, please feel free to contact me at trevor.lessard@pse.com.


Sincerely,


Trevor Lessard Municipal Land Planner PUGET SOUND ENERGY

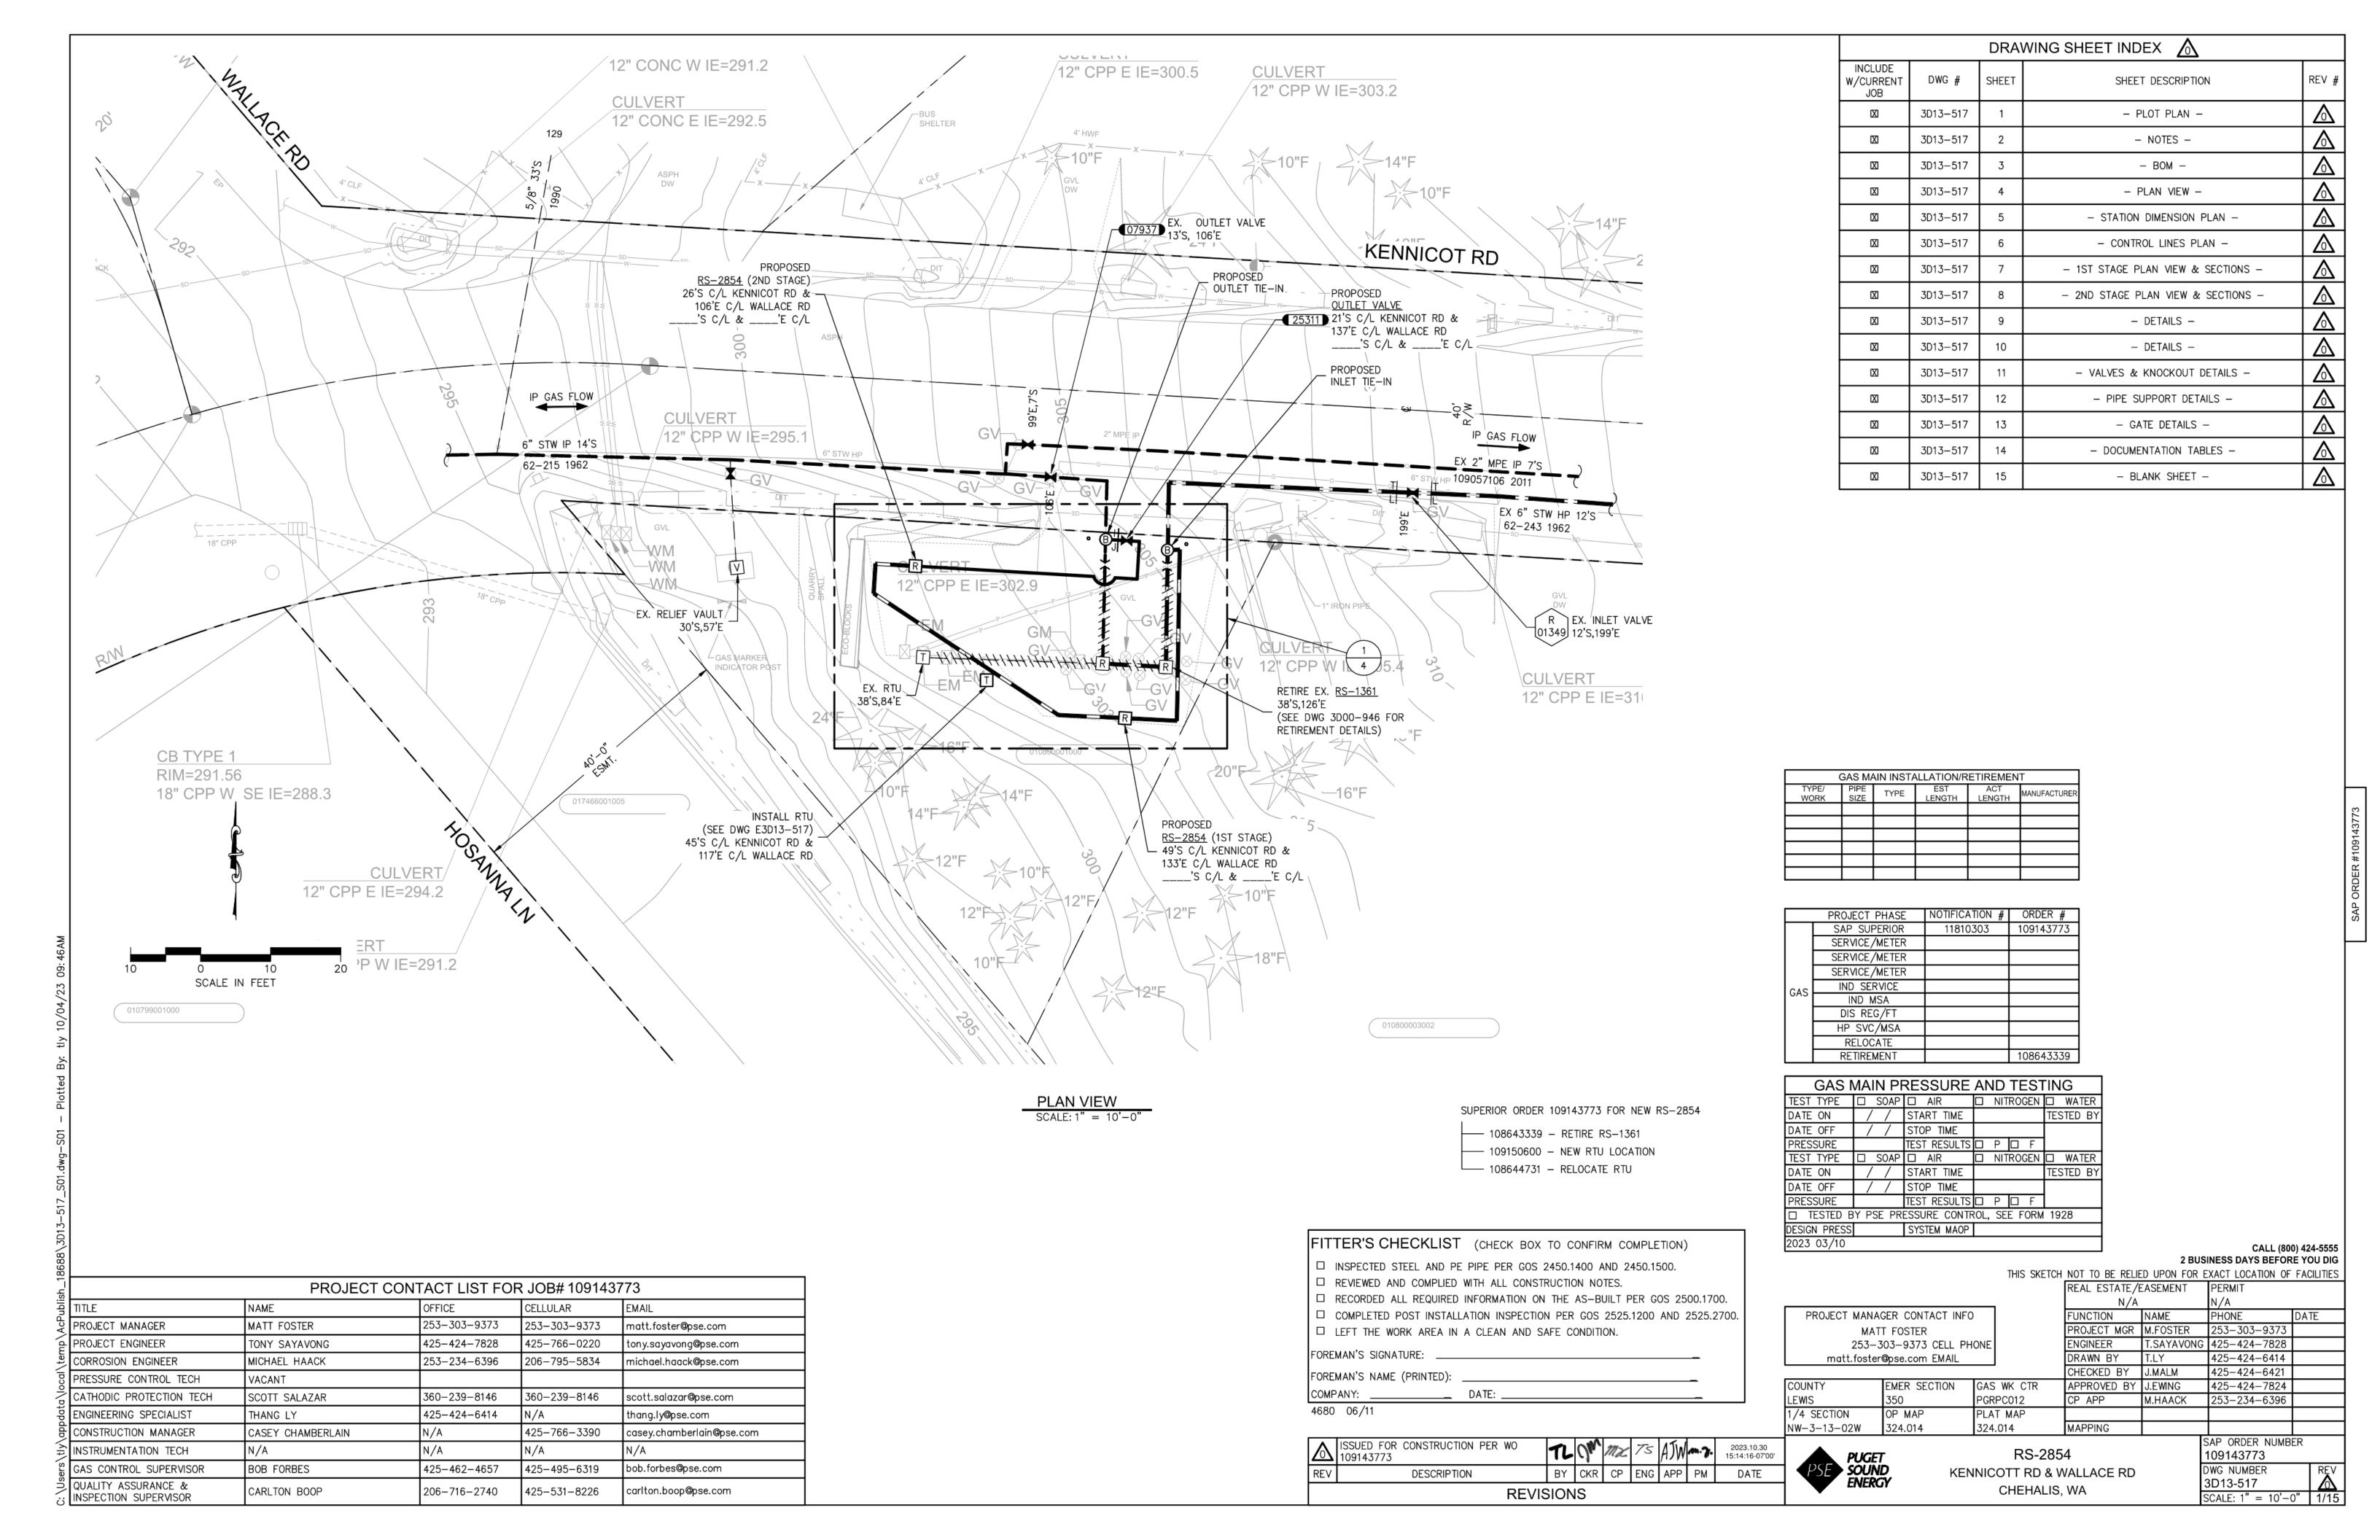


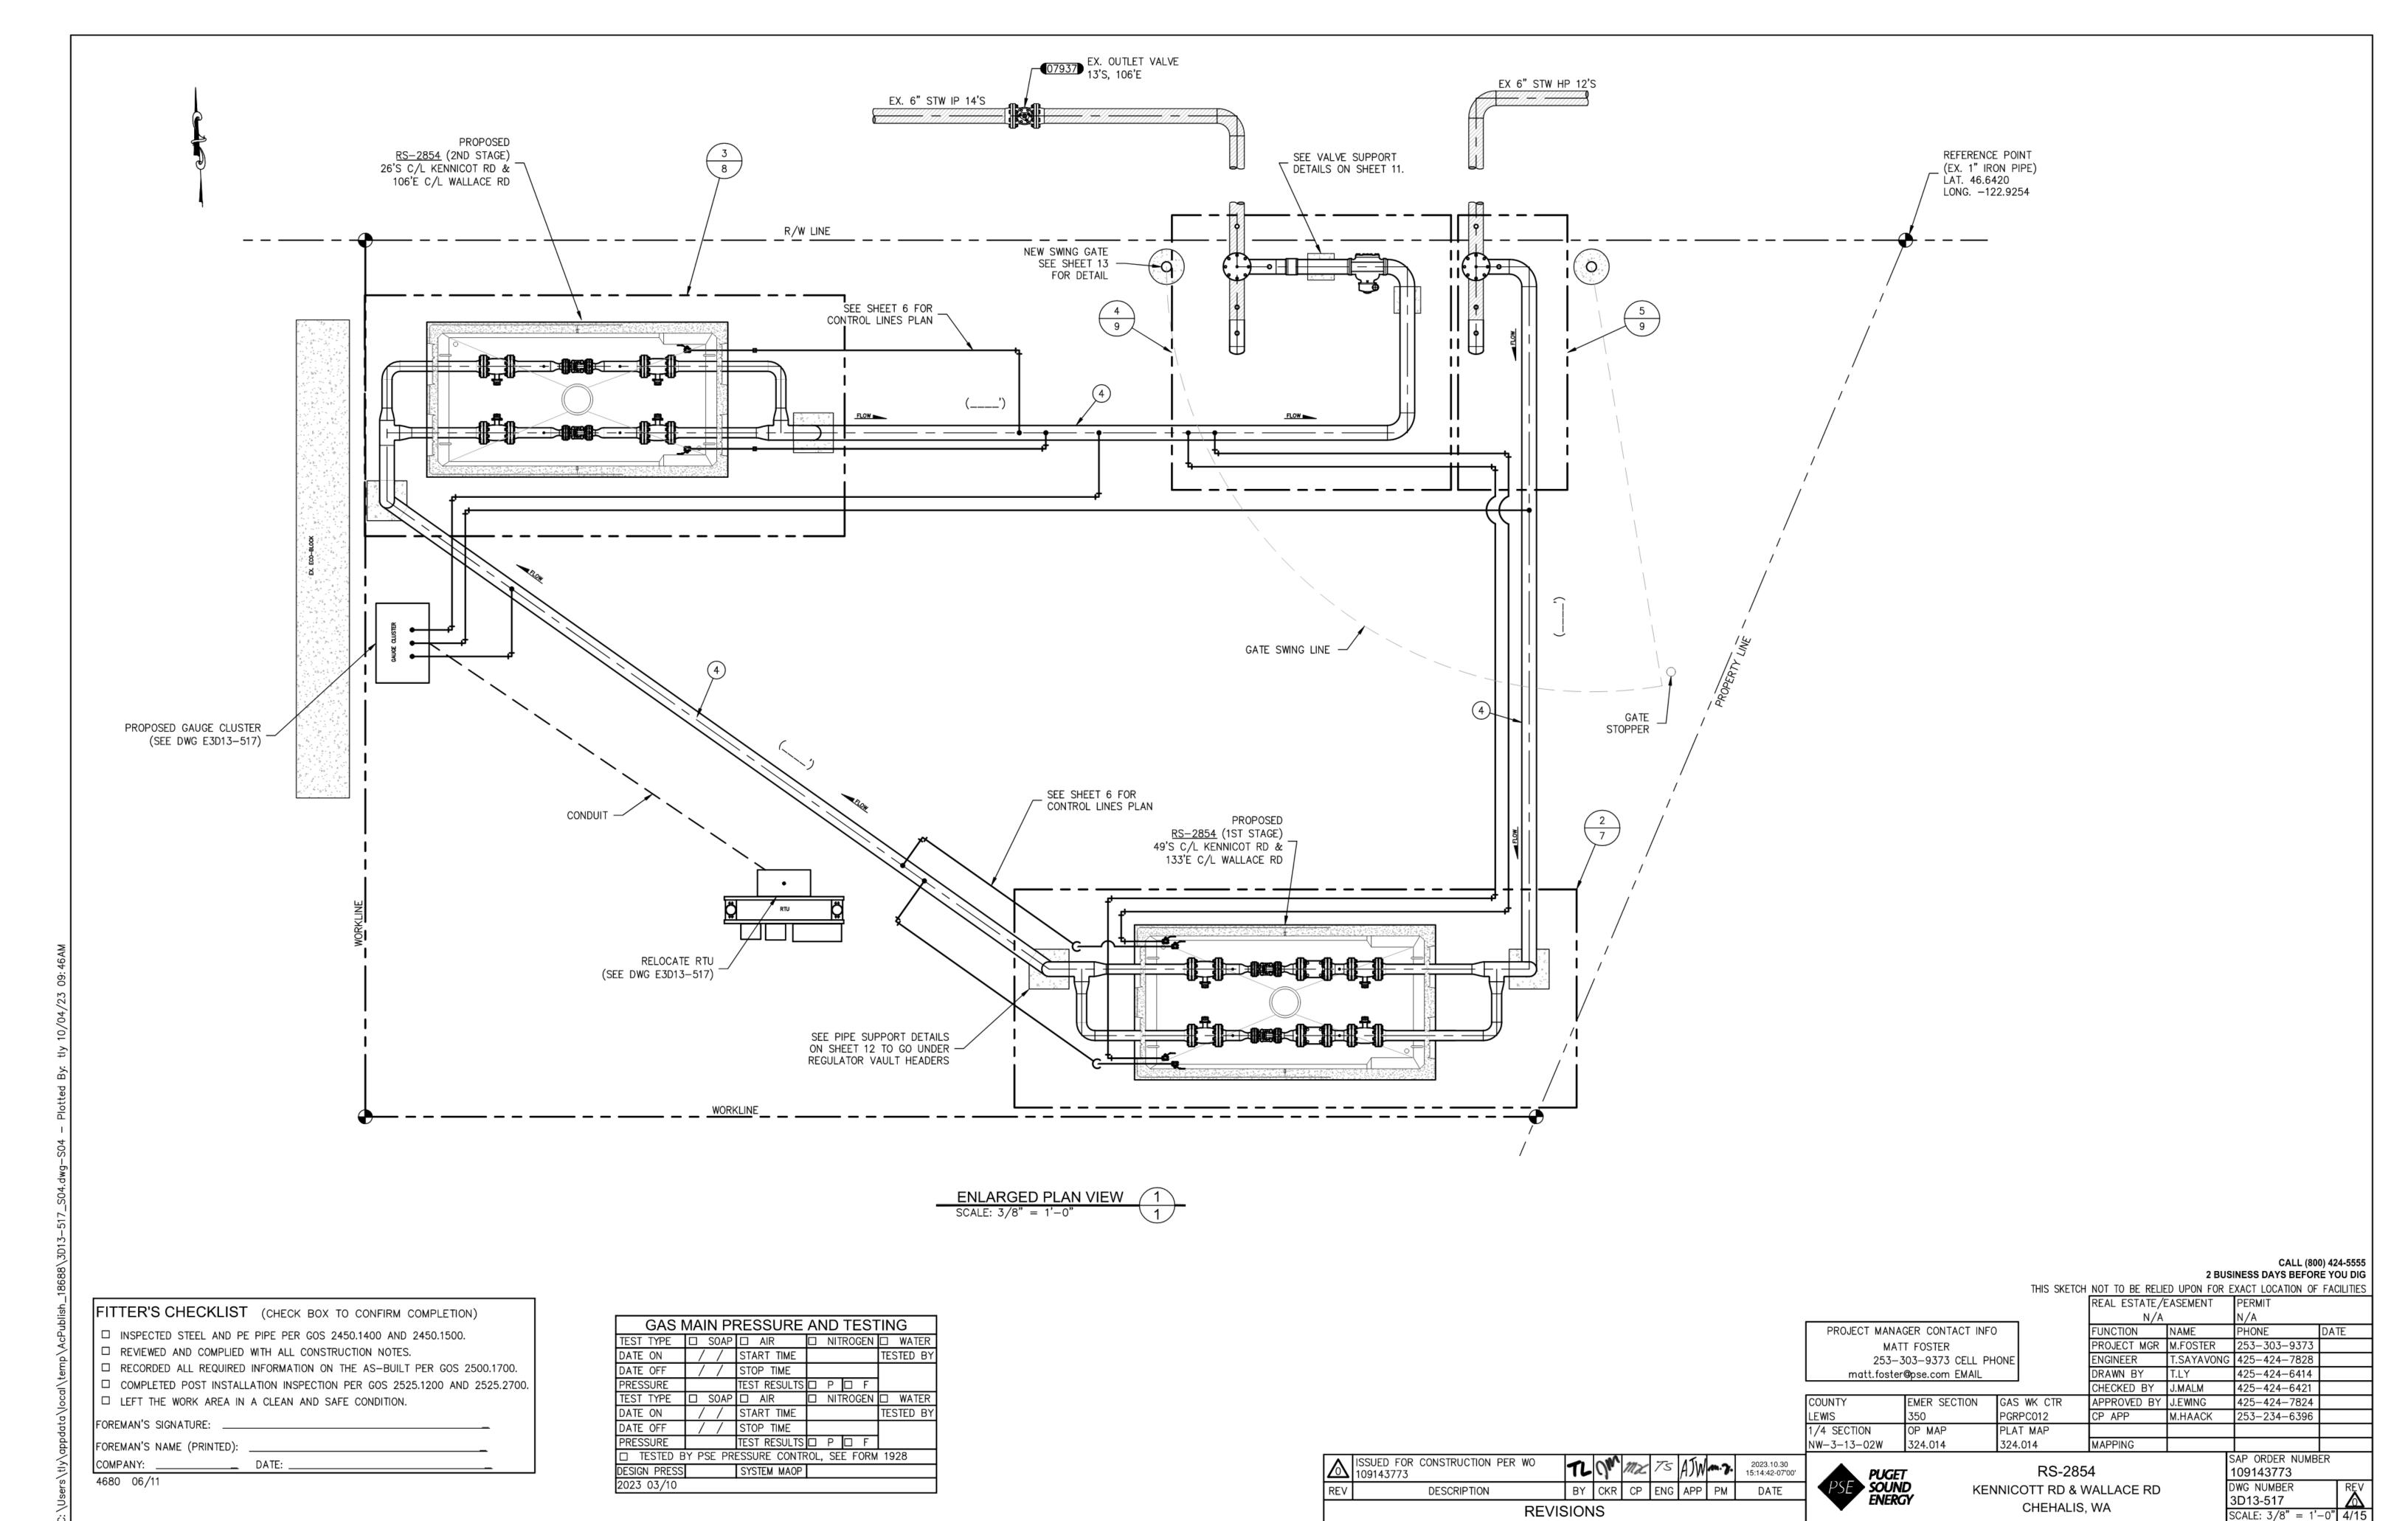


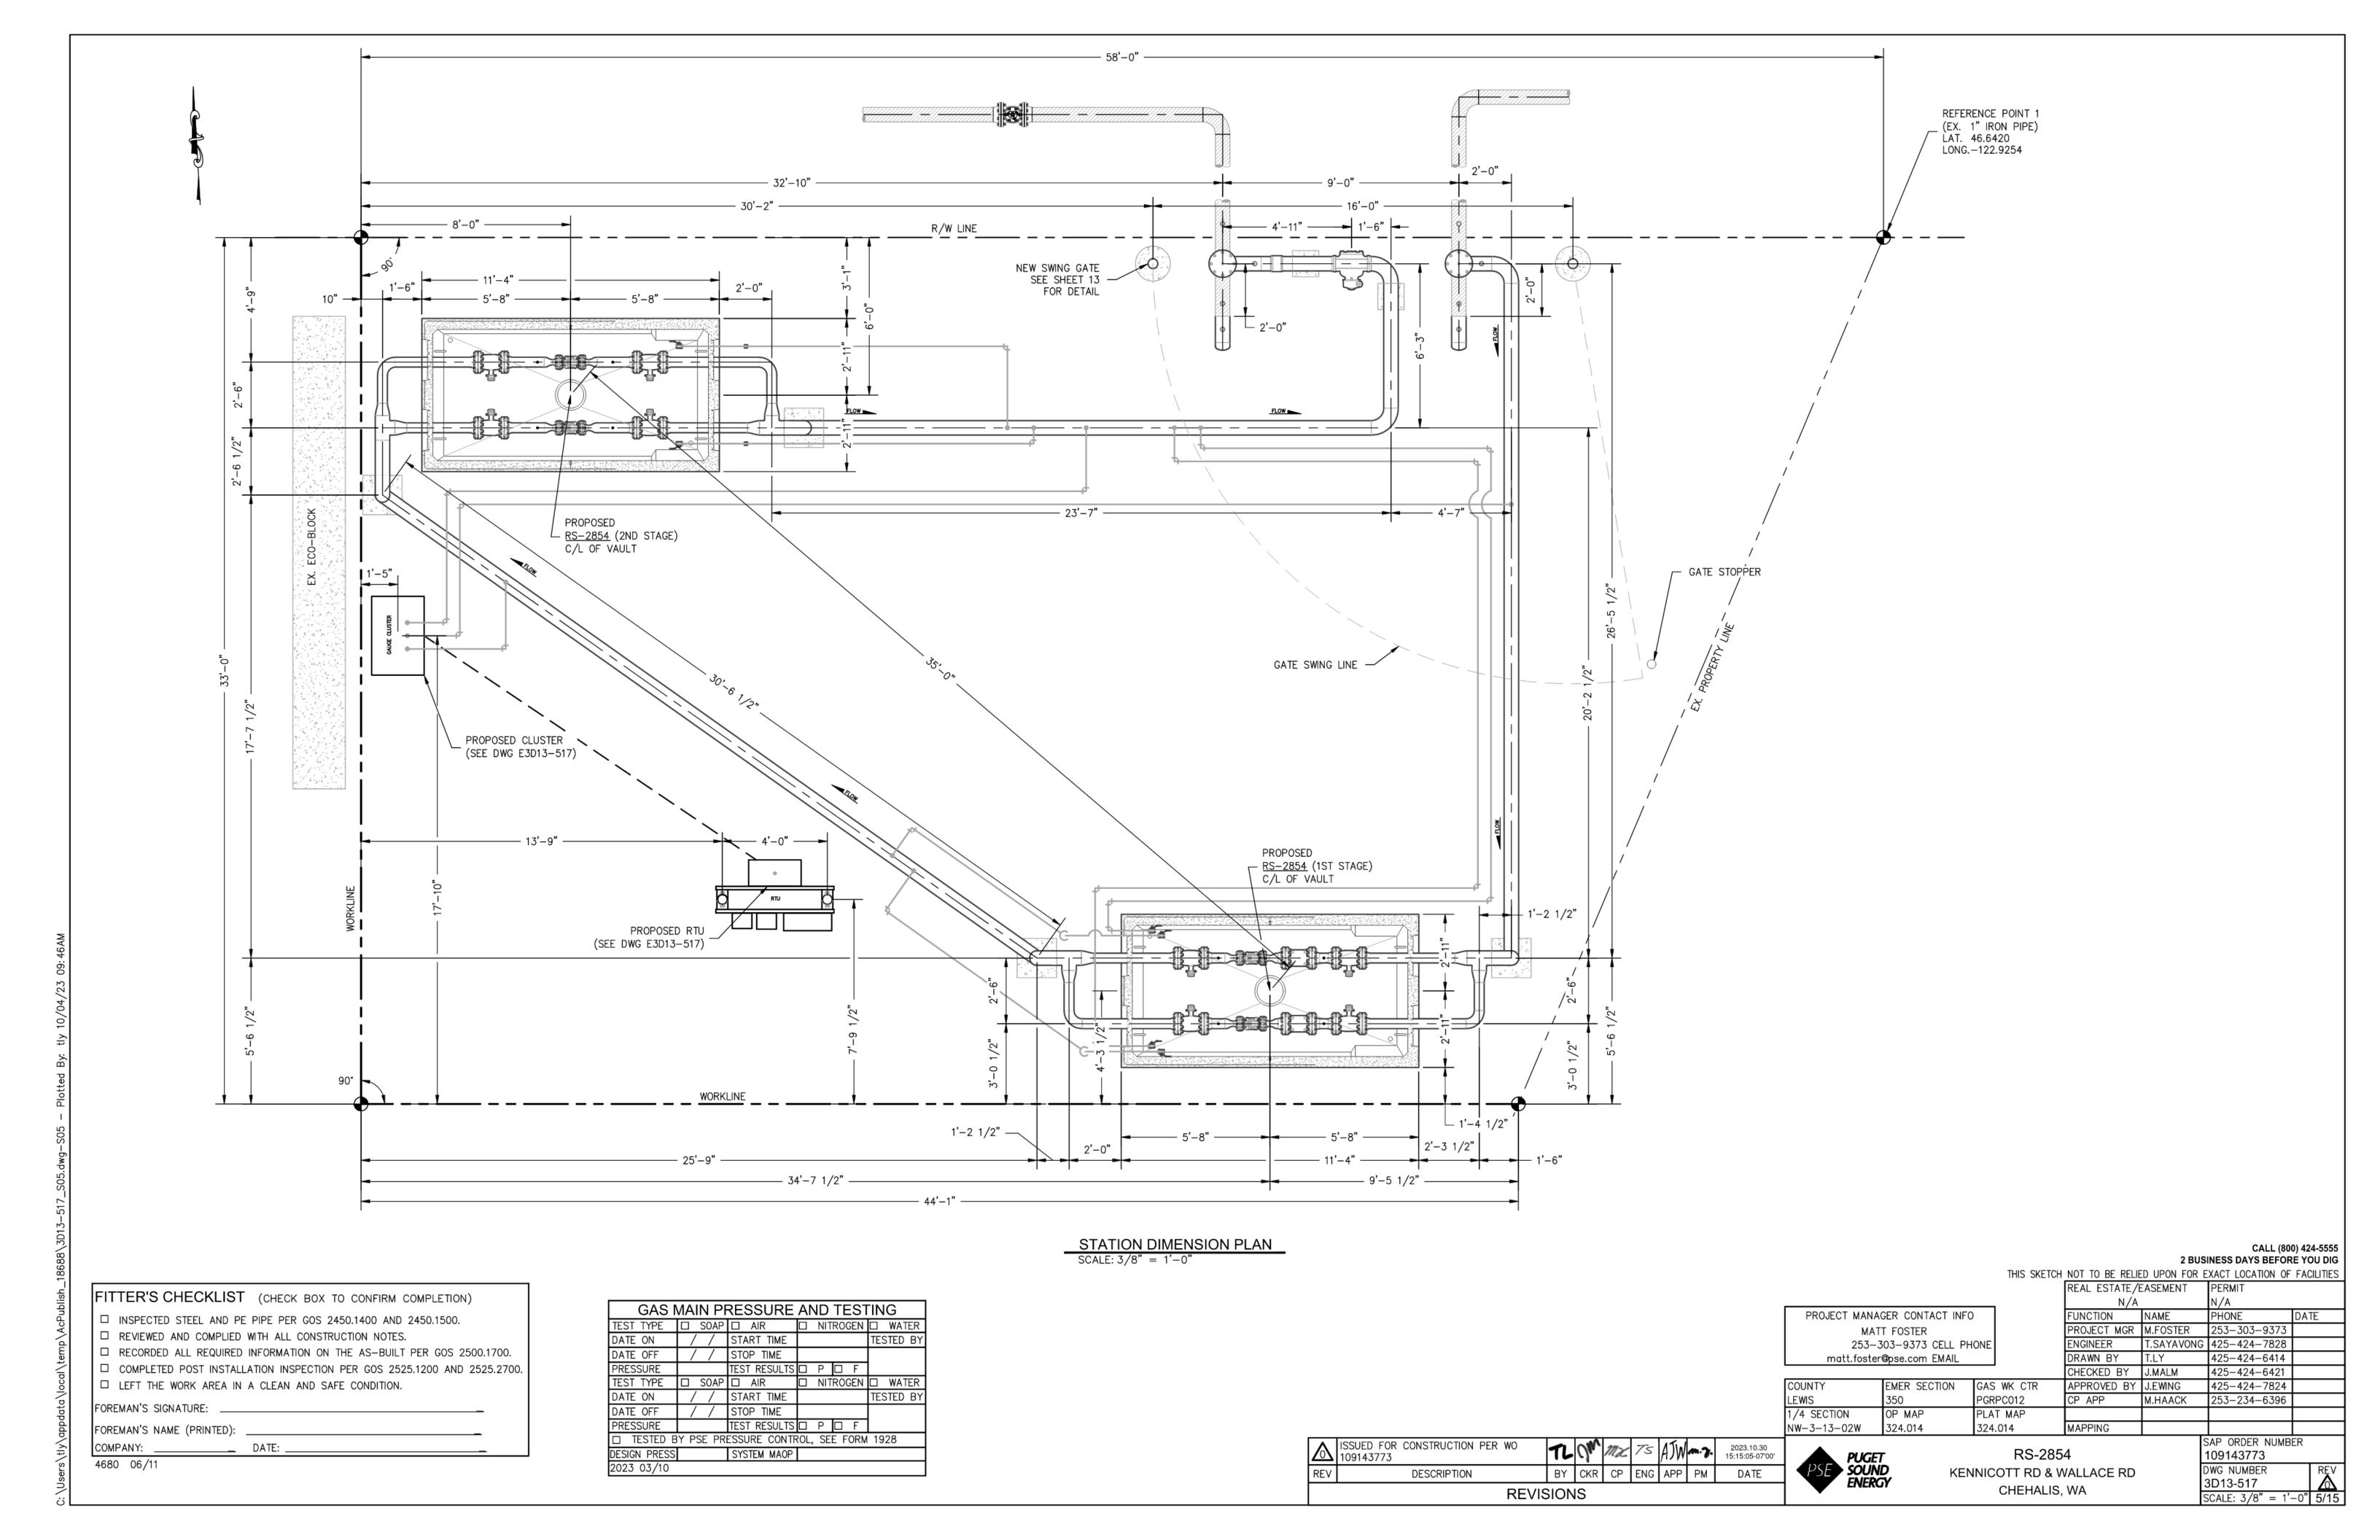


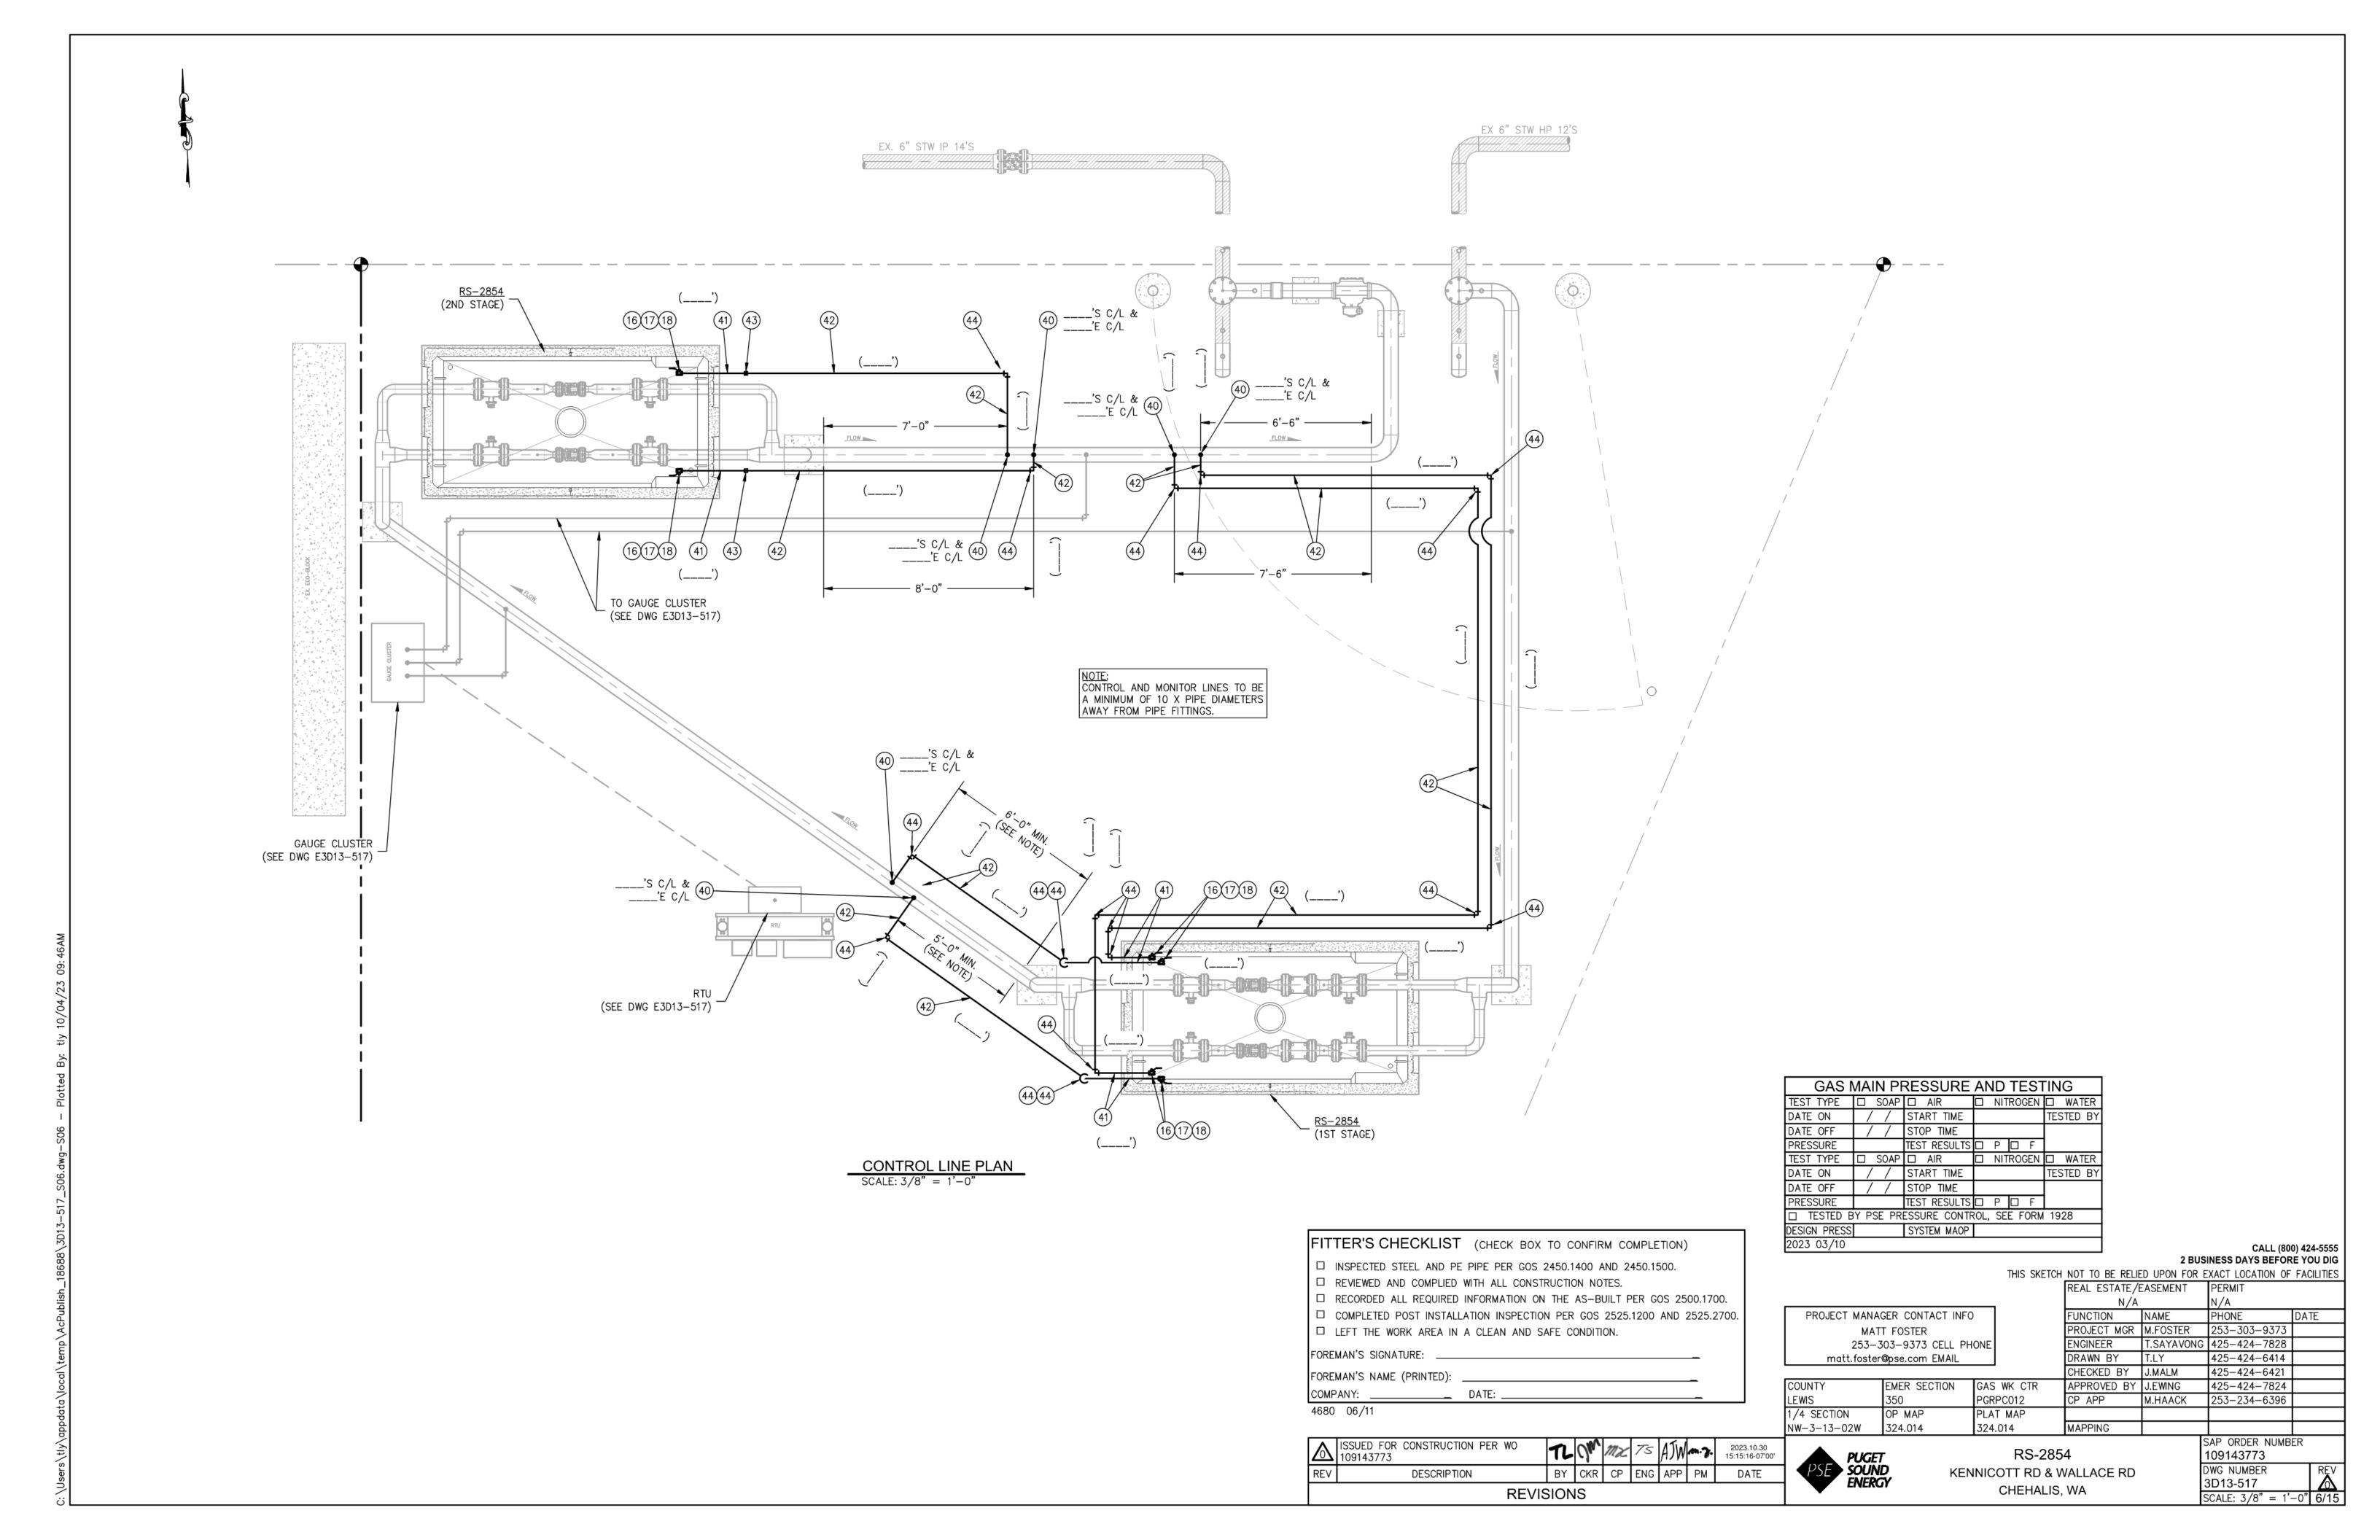

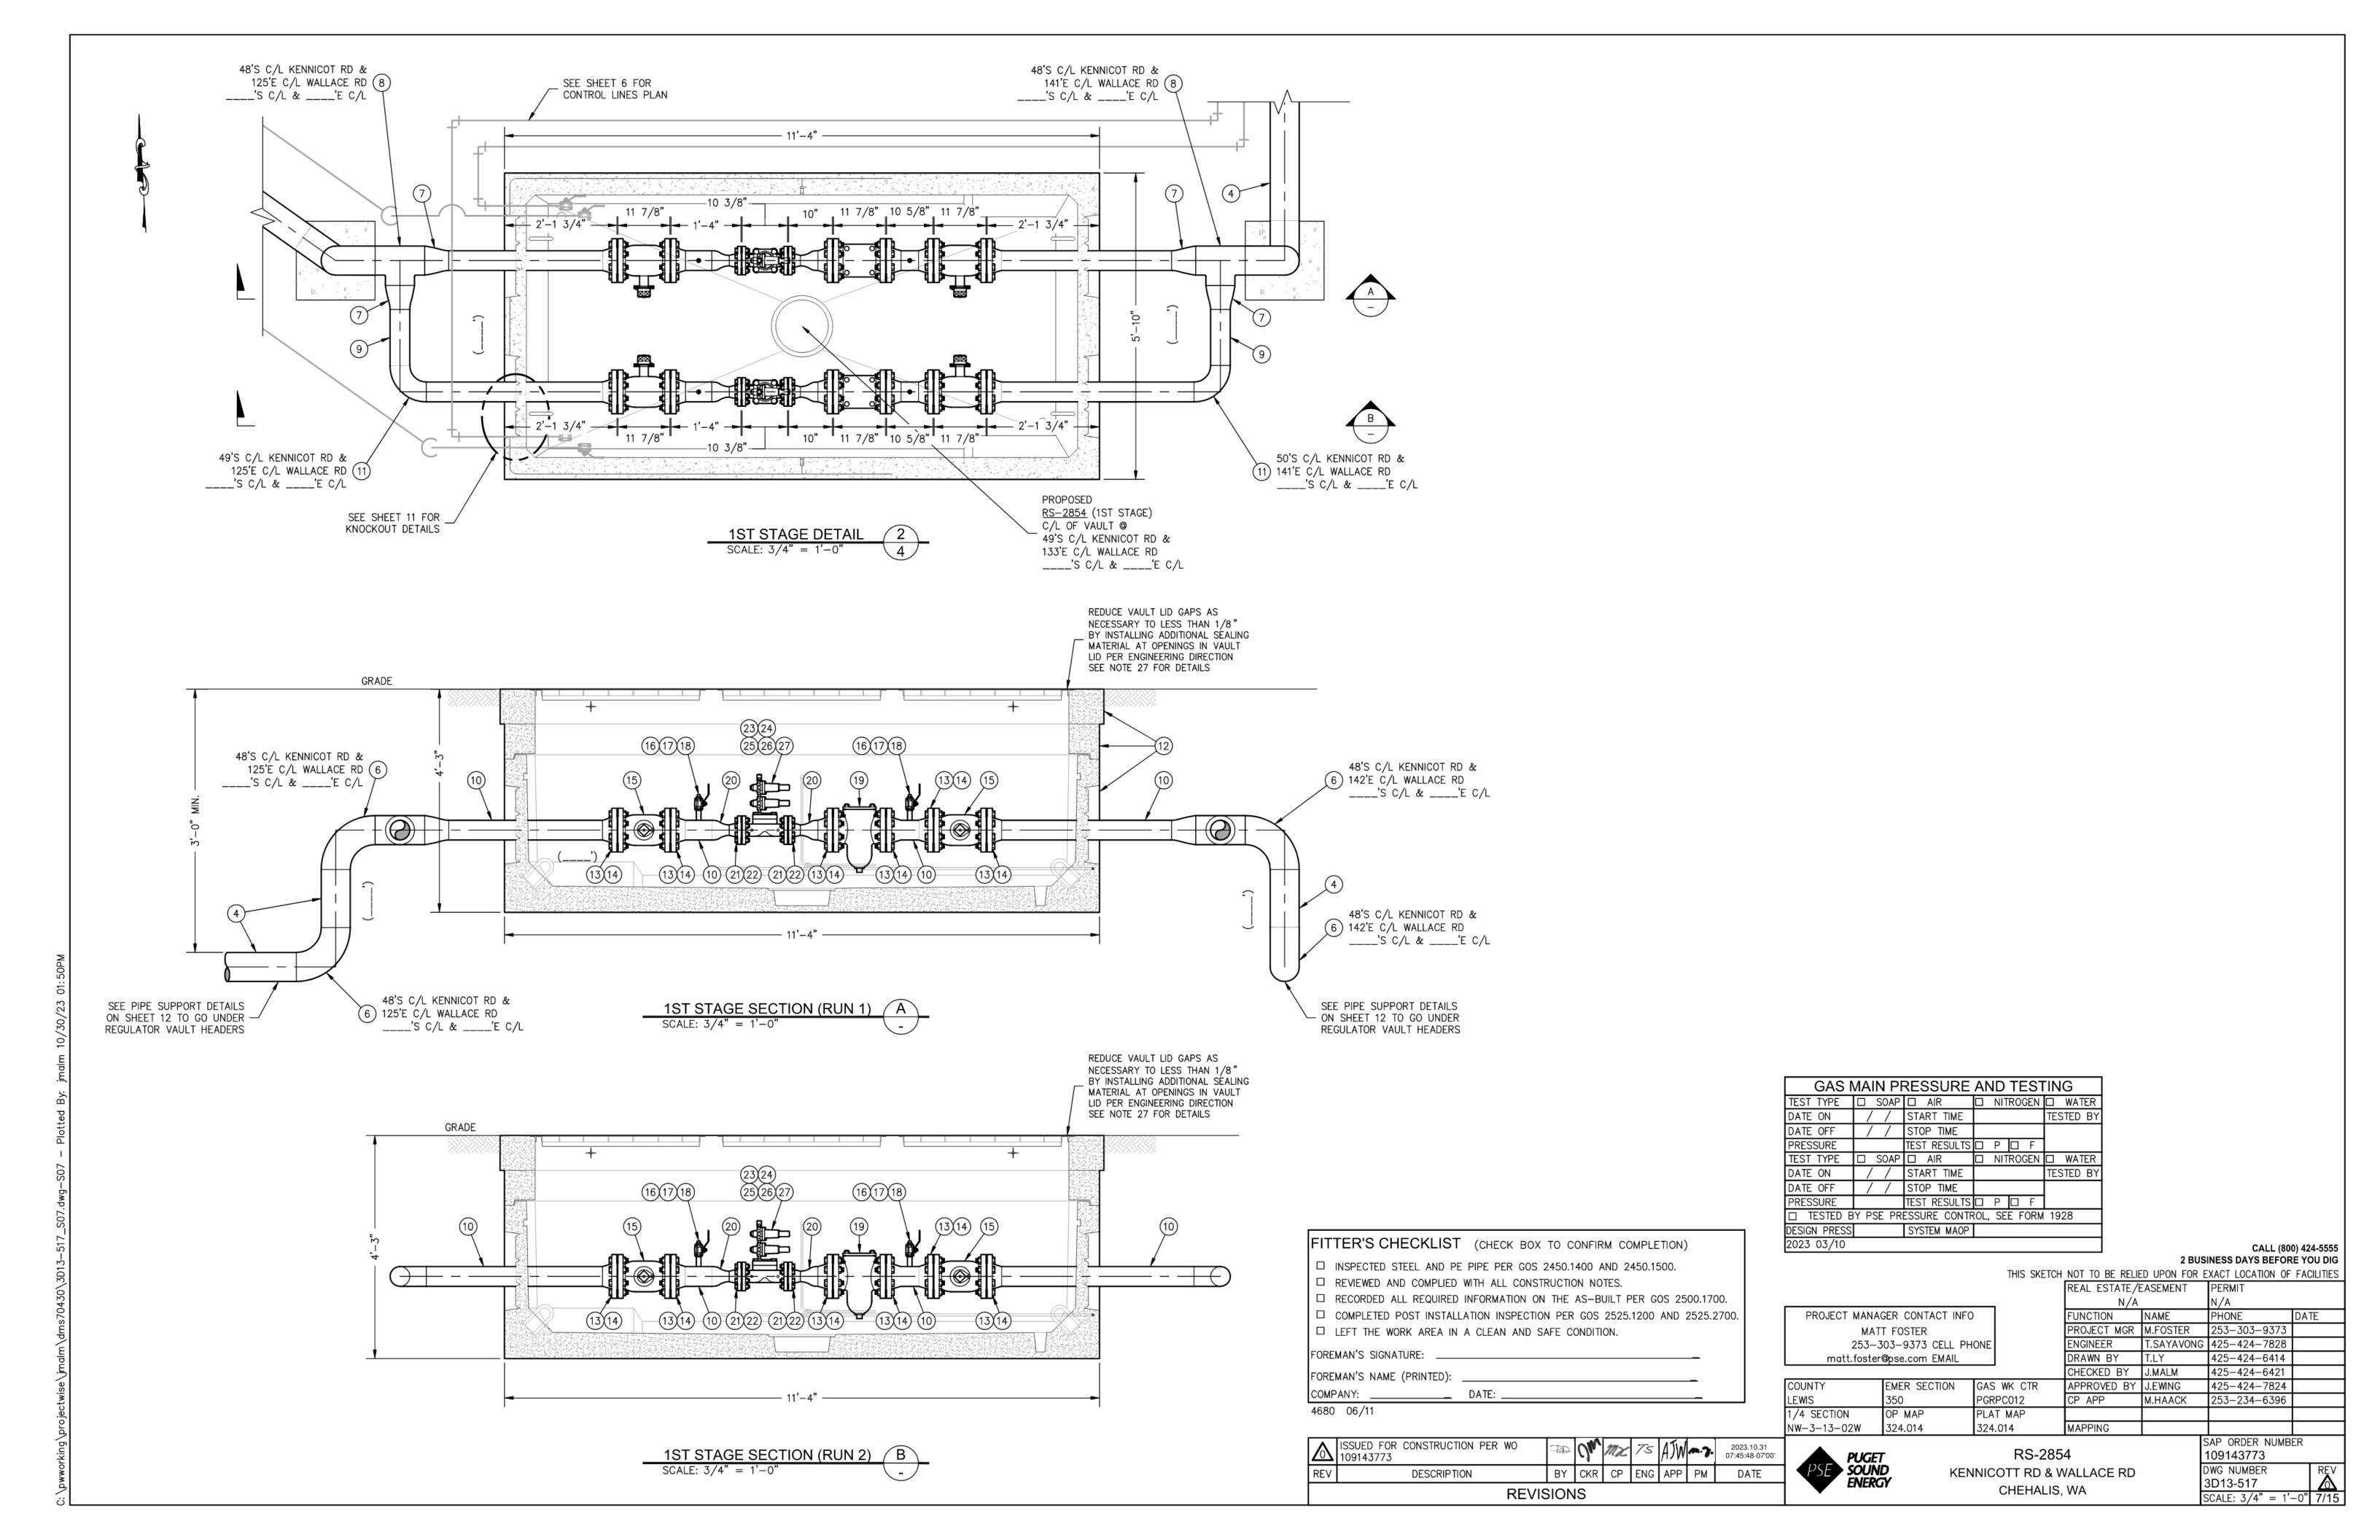

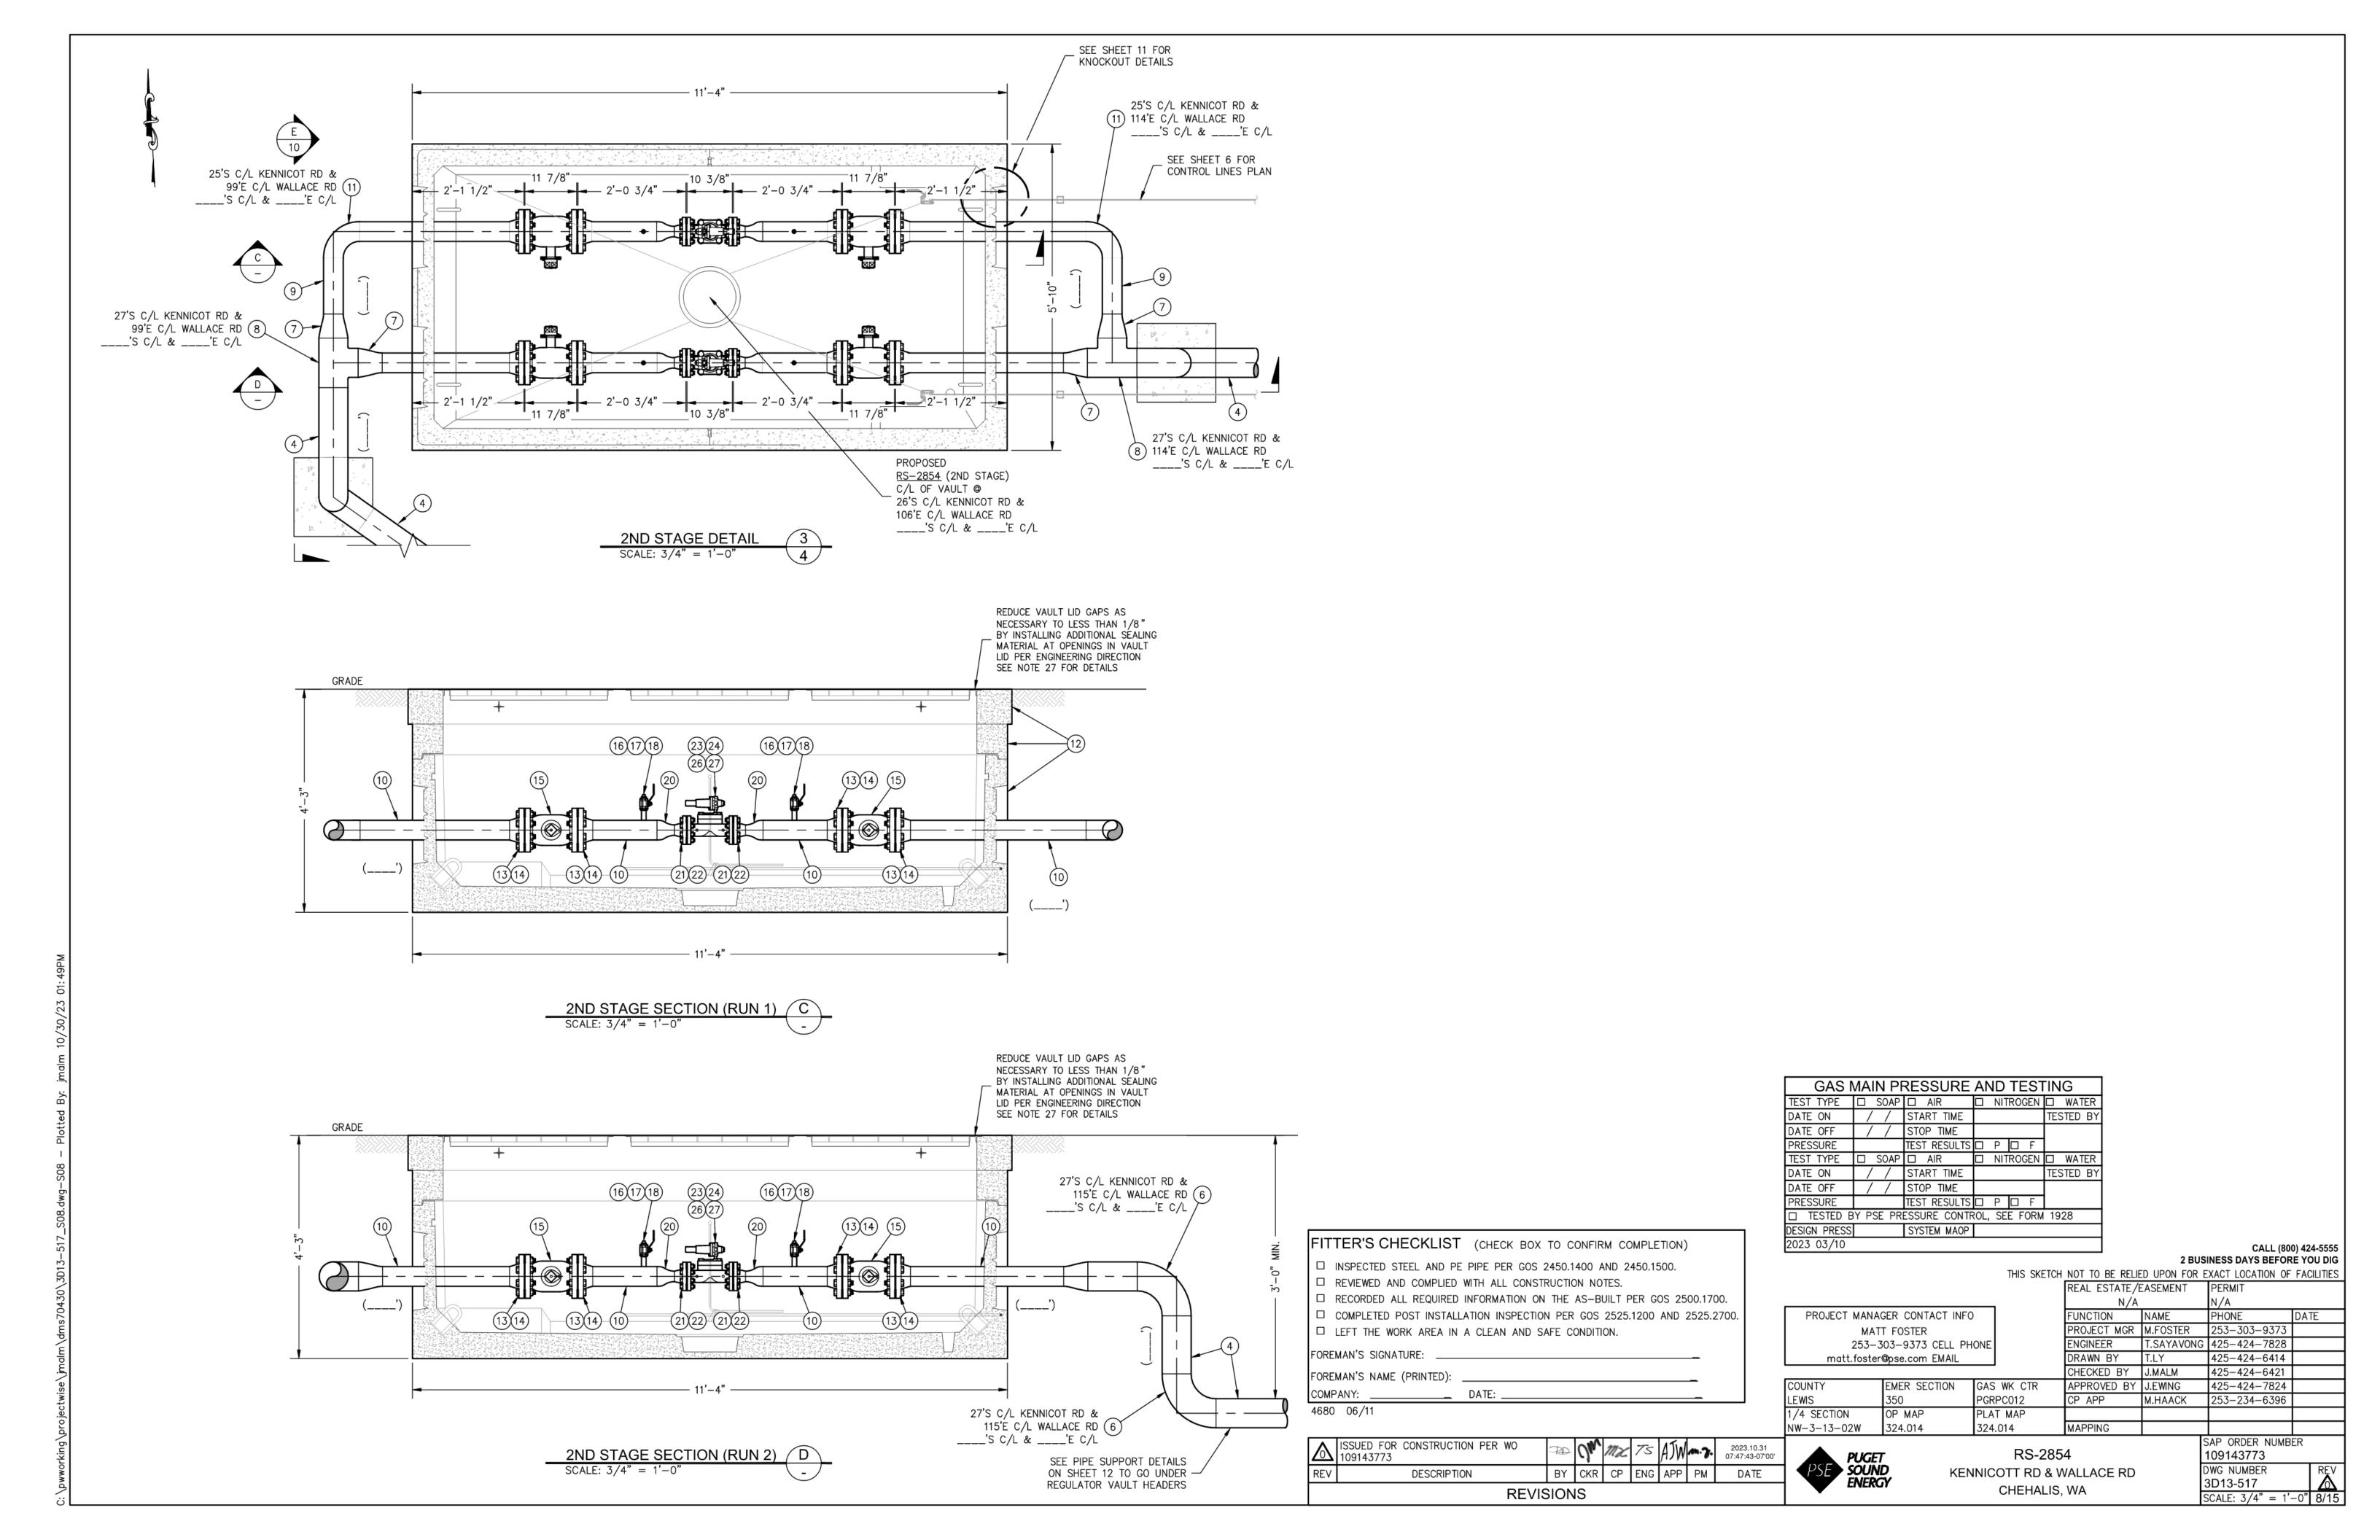

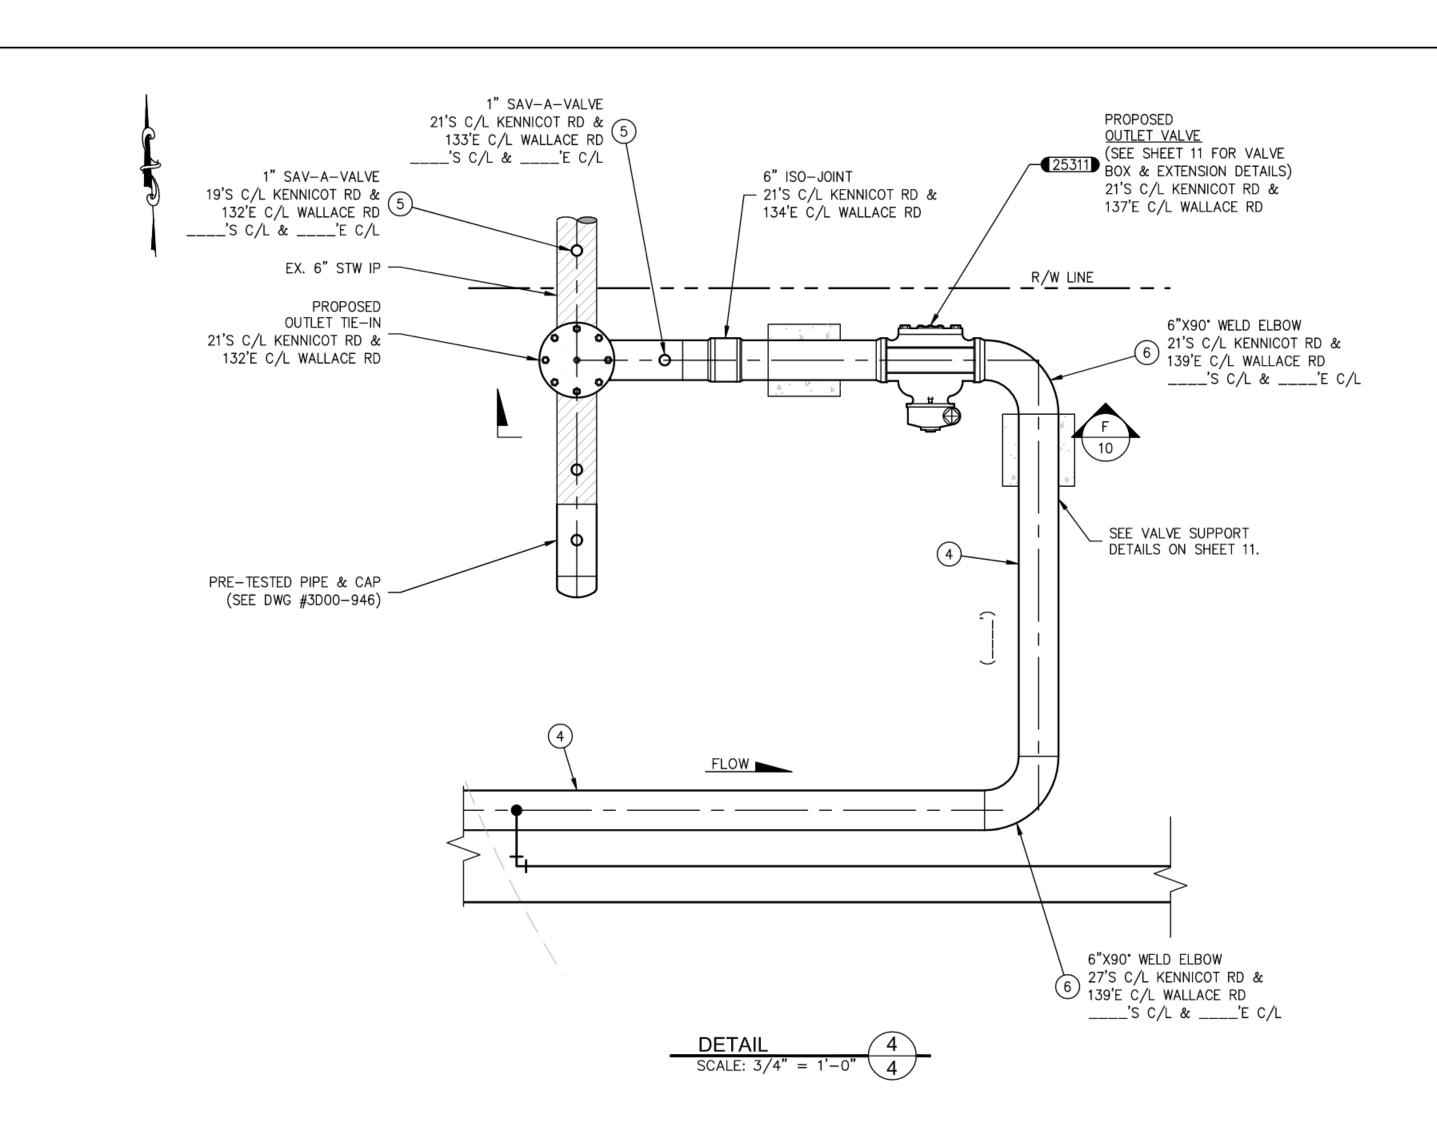

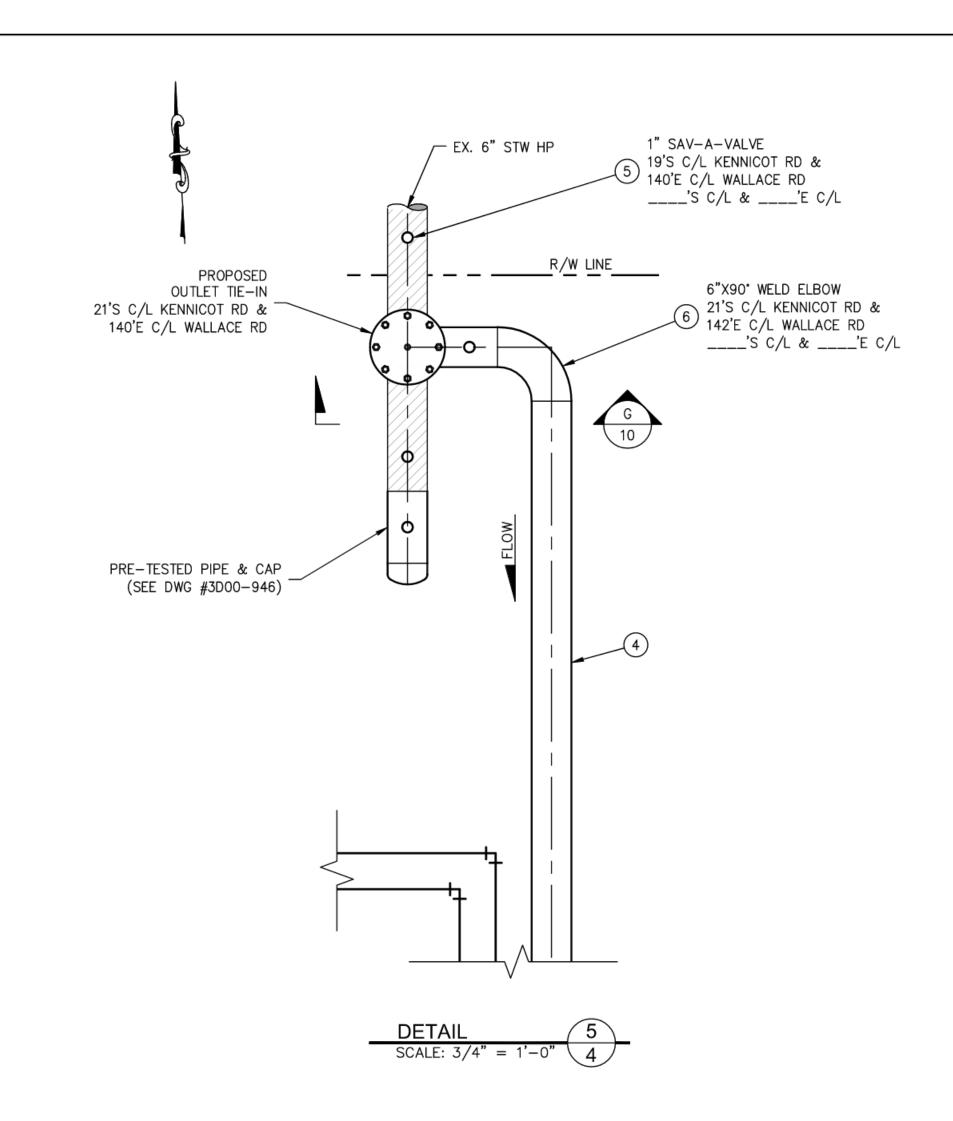

FITTER'S CHECKLIST (CHECK BOX TO CONFIRM COMPLETION)

INSPECTED STEEL AND PE PIPE PER GOS 2450.1400 AND 2450.1500.

REVIEWED AND COMPLIED WITH ALL CONSTRUCTION NOTES.

RECORDED ALL REQUIRED INFORMATION ON THE AS-BUILT PER GOS 2500.1700.

COMPLETED POST INSTALLATION INSPECTION PER GOS 2525.1200 AND 2525.2700.

LEFT THE WORK AREA IN A CLEAN AND SAFE CONDITION.

FOREMAN'S SIGNATURE:

FOREMAN'S NAME (PRINTED):

COMPANY:

DATE:

ISSUED FOR CONSTRUCTION PER WO 109143773

REV DESCRIPTION BY CKR CP ENG APP PM DATE

REVISIONS

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2023 03/10							

CALL (800) 424-5555 2 BUSINESS DAYS BEFORE YOU DIG

THIS SKETCH NOT TO BE RELIED UPON FOR EXACT LOCATION OF FACILITIES

REAL ESTATE/EASEMENT PERMIT

N/A

N/A


PROJECT MANAG	GER CONTACT INFO		FUNCTION	NAME	PHONE	DATE
MAT	T FOSTER		PROJECT MGR	M.FOSTER	253-303-9373	
253-3	03-9373 CELL PH	ONE	ENGINEER	T.SAYAVONG	425-424-7828	
matt.foster	©pse.com EMAIL		DRAWN BY	T.LY	425-424-6414	
			CHECKED BY	J.MALM	425-424-6421	
COUNTY	EMER SECTION	GAS WK CTR	APPROVED BY	J.EWING	425-424-7824	
LEWIS	350	PGRPC012	CP APP	M.HAACK	253-234-6396	
1/4 SECTION	OP MAP	PLAT MAP				
NW-3-13-02W	324.014	324.014	MAPPING			
				9	SAP ORDER NUMB	ER





RS-2854 KENNICOTT RD & WALLACE RD CHEHALIS, WA SAP ORDER NUMBER
109143773

DWG NUMBER
3D13-517

SCALE: 3/4" = 1'-0" 9/15

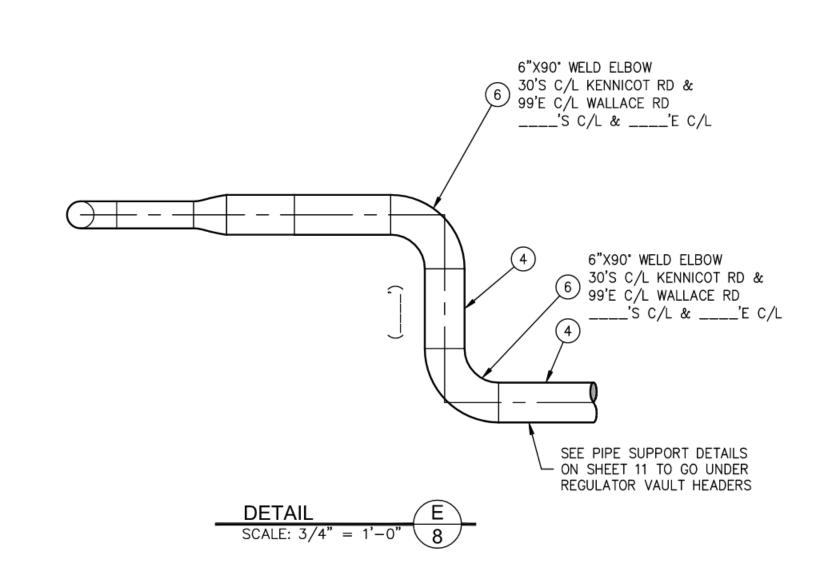

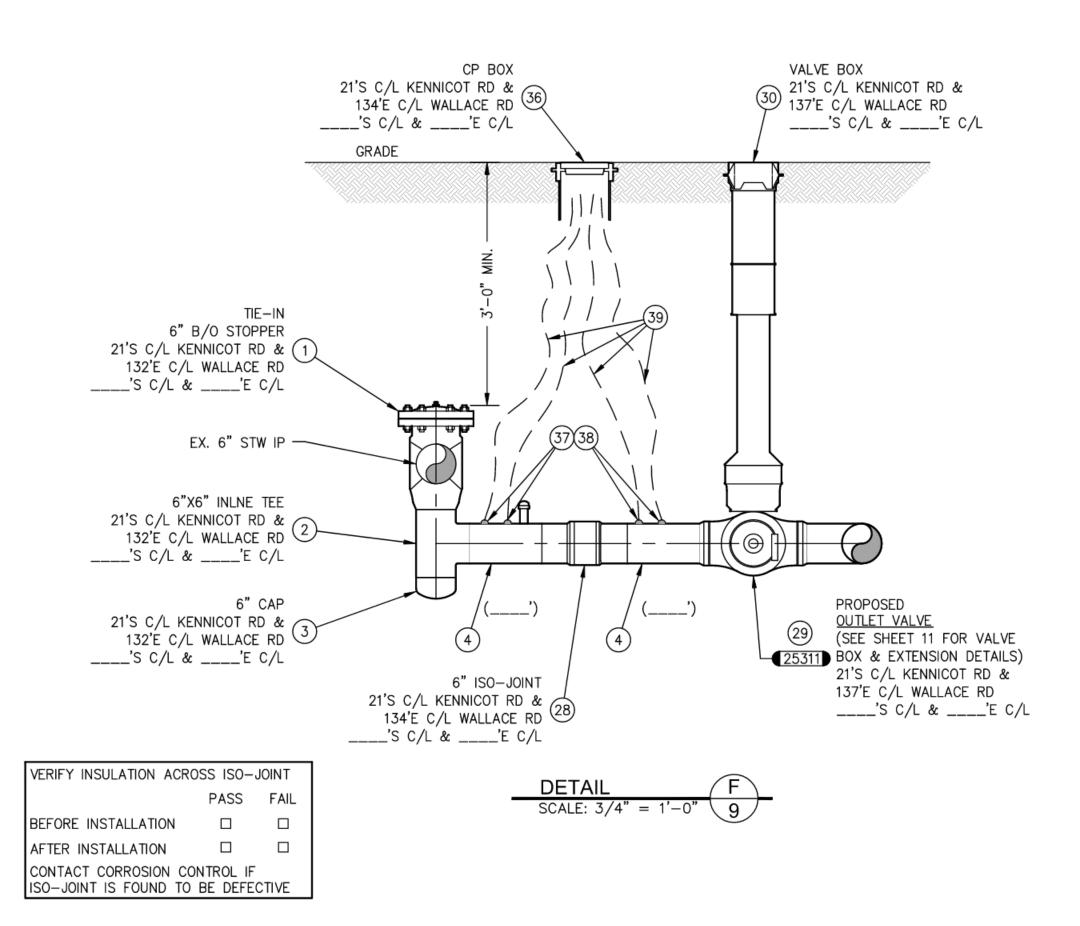

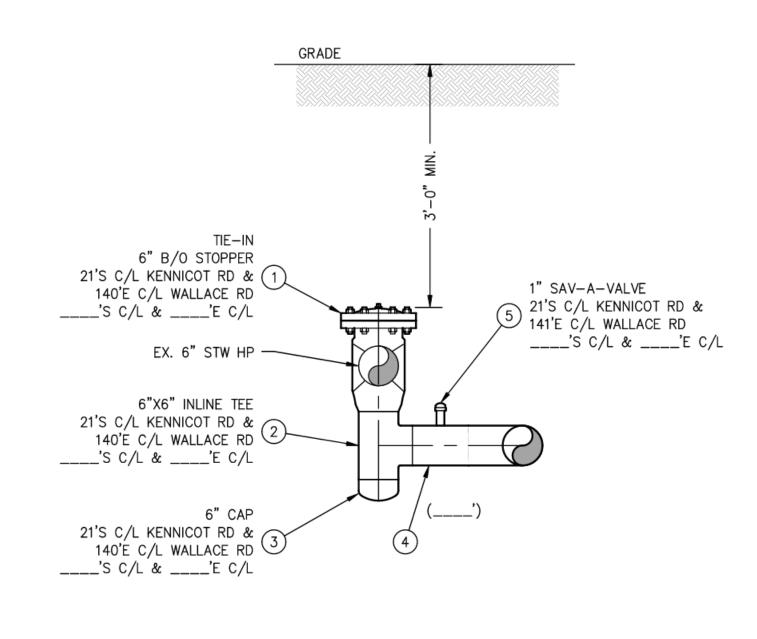

DETAIL

SCALE: 3/4" = 1'-0" 9

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FOREMAN'S SIGNATURE:

FOREMAN'S NAME (PRINTED):

COMPANY:

DATE:

DATE:

4680 06/11

\triangle	ISSUED FOR CONSTRUCTION PER WO 109143773	TL	On	MX	Ts	AJW	m.Z.	2023.10.30 15:16:28-07'00'	
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DATE OFF	/ /	STOP TIME					
PRESSURE		TEST RESULTS		Р	□ F		
TEST TYPE	□ SOAP	☐ AIR		NITE	ROGEN		WATER
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DATE OFF	/ /	STOP TIME					
PRESSURE		TEST RESULTS		Р	□ F		
☐ TESTED BY PSE PRESSURE CONTROL, SEE FORM 1928							
DESIGN PRESS		SYSTEM MAOP					
2023 03/10							

CALL (800) 424-5555
2 BUSINESS DAYS BEFORE YOU DIG

THIS SKETCH NOT TO BE RELIED UPON FOR EXACT LOCATION OF FACILITIES

REAL ESTATE/EASEMENT
N/A
N/A

PROJECT MANAGER CONTACT INFO
MATT FOSTER
253-303-9373 CELL PHONE
matt.foster@pse.com EMAIL

THIS SKETCH NOT TO BE RELIED UPON FOR EXACT LOCATION OF FACILITIES

REAL ESTATE/EASEMENT
N/A
N/A

FUNCTION NAME
PHONE
PROJECT MGR M.FOSTER
253-303-9373
ENGINEER
T.SAYAVONG 425-424-7828
DRAWN BY T.LY
425-424-6414
CHECKED BY J.MALM
425-424-6421

425-424-6414 425-424-6421 APPROVED BY J.EWING EMER SECTION GAS WK CTR 425-424-7824 LEWIS PGRPC012 CP APP M.HAACK 253-234-6396 1/4 SECTION PLAT MAP OP MAP NW-3-13-02W 324.014 324.014 MAPPING



RS-2854 KENNICOTT RD & WALLACE RD CHEHALIS, WA SAP ORDER NUMBER
109143773

DWG NUMBER
3D13-517

SCALE: 3/4" = 1'-0" 10/15

A SMALL CONCRETE PAD-APPROX. 36" X 48" X 6" D - AROUND THE VALVE

4. TOP OF EXTENSION TO BE BETWEEN 3" AND 6" BELOW BOTTOM OF CP BOX LID.

3. GREASE EXTENSION TO BE CENTERED IN THE CP BOX, AND TO BE ORIENTED

5. TERMINATIONS IN VALVE BOX TO BE ORIENTED VERTICALLY, WITH NO

B) 2" BETWEEN ANY EXTENSION AND VAULT WALL.


AND CP BOXES.

PERCEPTIBLE TILT.

VERTICALLY, WITH NO PERCEPTIBLE TILT.

6. MINIMUM CLEARANCES OF EXTENSIONS IN VAULT:


A) 3" BELOW BOTTOM OF VAULT LID

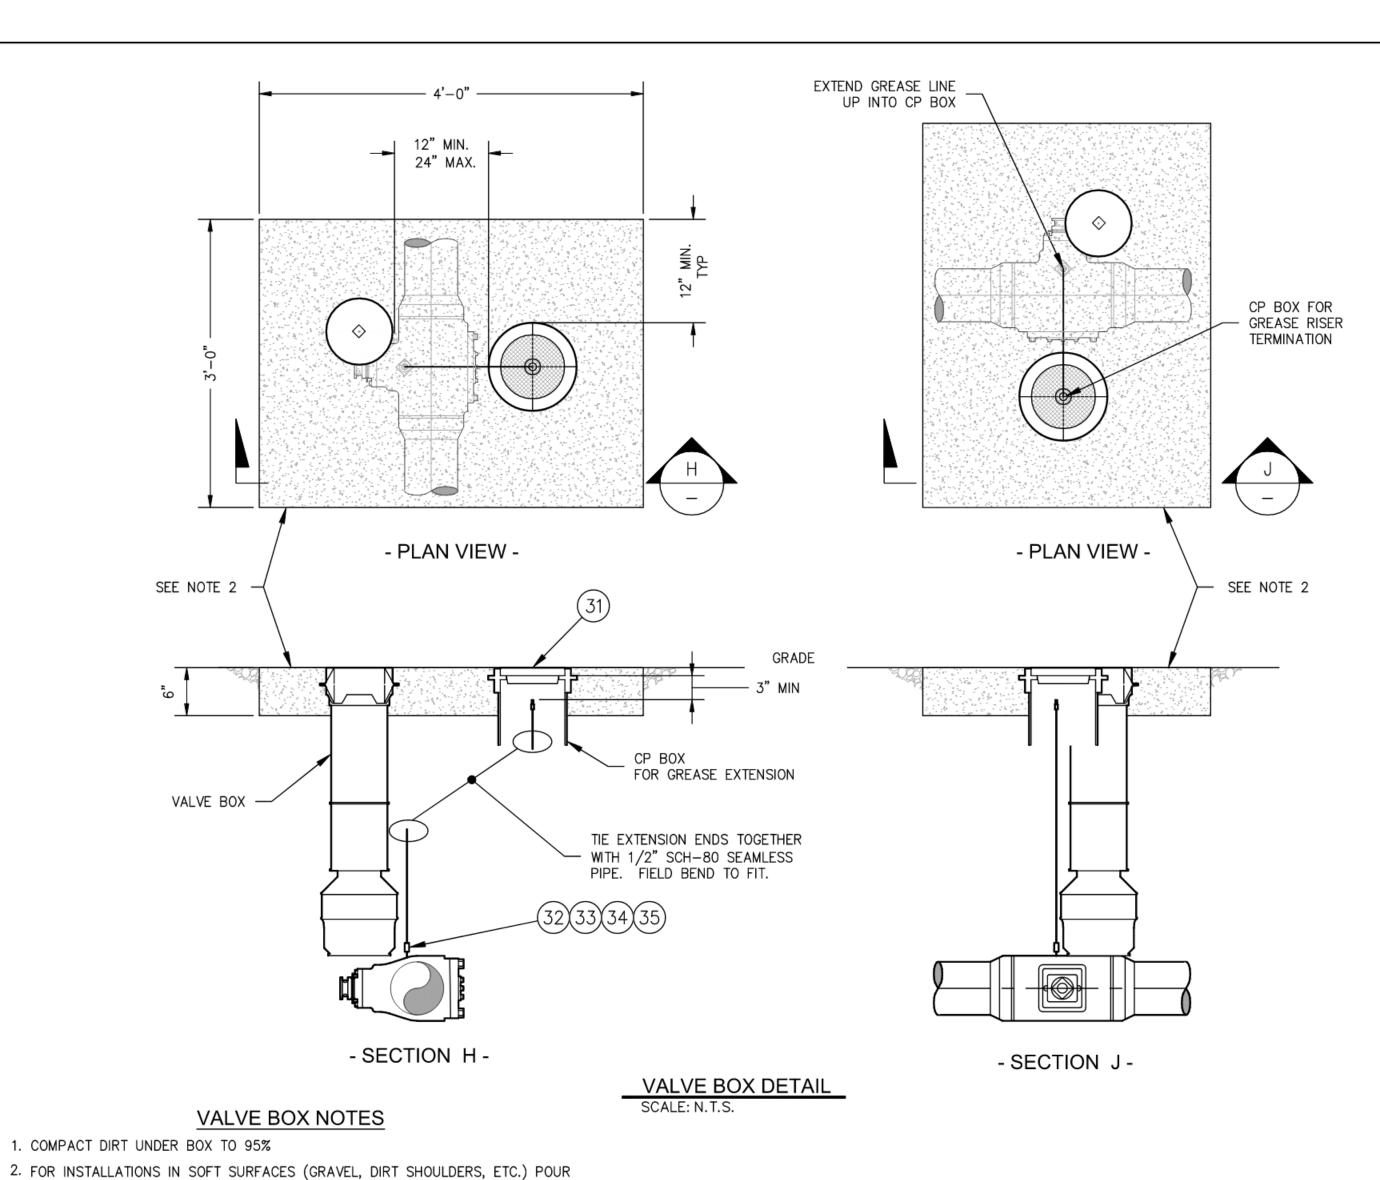

CP SHIELD CP SHIELD SEE NOTE 2 SEE NOTE 2 **──** 1'-0" **─**► SANDBAG DAM CONCRETE FORM

VALVE SUPPORT INSTALLATION SCALE: N.T.S.


- 1. MAXIMUM ALLOWABLE WALL MISMATCH FOR WELDING IS 3/32". IF NECESSARY, TAPER BORE END(S) OF PIPE PER ANSI/ASME B31.8. APPENDIX I. FIG I (B) TO GET WITHIN TOLERANCE.
- 2. INSTALL 30" LONG 240 DEGREE FIBERGLASS REINFORCED PLASTIC (FRP) CP SHIELD AT LOCATIONS OF CONCRETE VALVE SUPPORTS. SHIELD MAY BE PROVIDED BY GLASS MESH CO. OR OTHER COMPANY WITH A COMPARABLE PRODUCT. APPLY CP SHIELD SEALER BETWEEN PIPE AND CP SHIELD. CP SHIELD MAY BE ATTACHED TO COATED PIPE. PIPE OR COATING SURFACE SHALL BE FREE OF OIL, GREASE, DIRT, OR OTHER CONTAMINANTS. SUFFICIENT SEALER SHALL BE APPLIED SO THAT IT OOZES OUT AROUND THE EDGES, SEALING THE PERIMTER OF THE CP SHIELD, WHEN IT IS PRESSED INTO PLACE.
- 3. DURING OR PRIOR TO VALVE INSTALLATION, REMOVE STANDARD GREASE FITTING AND INSTALL APPROPRIATE LENGTH EXTENDED GREASE PIPE USING 1/2" SCHEDULE 80 PIPE AND FITTINGS. REUSE STANDARD GREASE FITTING AT TOP OF EXTENDED GREASE PIPE AND TERMINATE FITTINGS 4" BELOW TEST LEAD BOX LID. COAT PIPE WITH FIELD COATING, PER GAS OPERATING STANDARD 2600.1100.
- 4. PSE PRESSURE CONTROL TO PACK GREASE EXTENSION BEFORE VALVE IS BACKFILLED.
- 5. POUR CONCRETE VALVE SUPPORTS AFTER VALVE HAS BEEN WELDED TO MAIN. IF DITCH IS WIDER THAN 24", USE SAND BAGS FOR SIDE BARRIERS. SUPPORTS TO BE POURED ON SOIL COMPACTED TO 95% DENSITY.

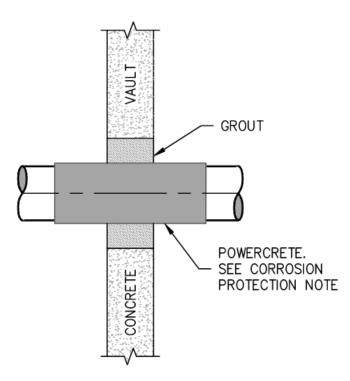

KNOCKOUT DETAIL

CORROSION PROTECTION NOTE

1. PIPING TO BE COATED IN R-95 POWERCRETE (MID #9998914) OR R-65 FAST-CURE POWERCRETE (MID #9999961) UP TO FIRST FITTING INSIDE REGULATOR VAULT AND 6" BEYOND OUTSIDE OF REGULATOR VAULT. APPLY APPROXIMATELY 30 MILS DRY FILM THICKNESS.

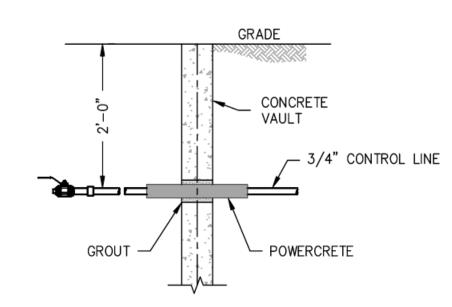

CONTROL LINE KNOCKOUT DETAIL SCALE: N.T.S.

FITTER'S CHECKLIST (CHECK BOX TO CONFIRM COMPLETION) ☐ INSPECTED STEEL AND PE PIPE PER GOS 2450.1400 AND 2450.1500.

☐ REVIEWED AND COMPLIED WITH ALL CONSTRUCTION NOTES.

 \square RECORDED ALL REQUIRED INFORMATION ON THE AS-BUILT PER GOS 2500.1700.

☐ COMPLETED POST INSTALLATION INSPECTION PER GOS 2525.1200 AND 2525.2700.

☐ LEFT THE WORK AREA IN A CLEAN AND SAFE CONDITION.

FOREMAN'S SIGNATURE: _____ FOREMAN'S NAME (PRINTED): COMPANY: _____ DATE: ____

4680 06/11

ISSUED FOR CONSTRUCTION PER WO 75 AJW --> 2023.10.30 15:17:25-07'00' BY CKR CP ENG APP PM DESCRIPTION DATE **REVISIONS**

GAS N	MAIN PF	RESSURE	AND TEST	ING
TEST TYPE	□ SOAP	□ AIR	□ NITROGEN	□ WATER
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PRESSURE		TEST RESULTS	□ P □ F	
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DESIGN PRESS		SYSTEM MAOP		
2023 03/10				

CALL (800) 424-5555 2 BUSINESS DAYS BEFORE YOU DIG THIS SKETCH NOT TO BE RELIED UPON FOR EXACT LOCATION OF FACILITIES

REAL ESTATE/EASEMENT PERMIT N/A PROJECT MANAGER CONTACT INFO FUNCTION NAME PHONE DATE PROJECT MGR M.FOSTER 253-303-9373 MATT FOSTER ENGINEER T.SAYAVONG 425-424-7828 253-303-9373 CELL PHONE DRAWN BY T.LY 425-424-6414 CHECKED BY J.MALM 425-424-6421 EMER SECTION GAS WK CTR APPROVED BY J.EWING 425-424-7824 PGRPC012 CP APP 253-234-6396 M.HAACK


matt.foster@pse.com EMAIL COUNTY LEWIS 1/4 SECTION OP MAP PLAT MAP NW-3-13-02W 324.014 324.014 MAPPING



RS-2854 KENNICOTT RD & WALLACE RD CHEHALIS, WA


SAP ORDER NUMBER 109143773 DWG NUMBER 3D13-517 SCALE: AS NOTED

- 2. FOR ANY STRAIGHT SEGMENTS OF PIPE TO BE IN CONTACT WITH CONCRETE, COAT PIPE WITH R-65 OR R-95 AND INSTALL FRP SHIELD OVER THE COATING.
- 3. FOUNDATION DESIGNED FOR A MINIMUM SOIL CAPACITY OF 1500PSF (TYPE B SOIL) AND A MAXIMUM 4 FEET OF SOIL COVER OVER PIPELINE. CALL PSE ENGINEERING IF COVER EXCEEDS 4 FEET. TO DETERMINE SOIL TYPE, REFER TO STANDARDS 0100.3200.
- 4. FOUNDATION SIZES IN THE TABLE ARE GIVEN AS H X W. REFER TO TABLE FOR VALUES. TABLE INCLUDES RISER SIZING CRITERIA. IF A RISER IS NOT PRESENT, REFER TO 2" OR LESS COLUMN FOR FOUNDATION SIZE. THE 'A' DIMENSION ON THE DRAWING CAN VARY AS NECESSARY, BUT SHALL NOT EXCEED ONE HALF THE OUTSIDE DIAMETER OF THE PIPE.
- 5. THE LENGTH OF THE FOUNDATION MUST BE AT A MINIMUM EQUAL TO THE WIDTH, BUT CAN VARY AS NECESSARY. REFER TO DRAWING FOR DIMENSIONS.
- 6. ON ANY ELBOWS TO BE IN CONTACT WITH CONCRETE WHERE AN FRP SHIELD IS NOT PRACTICAL TO INSTALL, INSTALL R-65 OR R-95 AND ROCKSHIELD BETWEEN THE COATED PIPE AND THE FOUNDATION. WRAP ROCKSHIELD AROUND PIPE CIGARETTE STYLE WITH 4" OVERLAP AT THE BOTTOM OF THE PIPE. TAPE IN PLACE WITH PIPE TAPE WRAPPED COMPLETELY AROUND PIPE AT EACH EDGE AND MIDDLE OF ROCKSHIELD. DO NOT USE PIPETAPE PRIMER.
- 7. CDF MIXTURE SHALL BE CADMAN PRO-FLOW GENERAL FILL OR EQUIVALENT. IT SHALL BE A FLOWABLE, COHESIVE, NON-BLEEDING MIX. CDF SHALL BE HAND/MACHINE EXCAVATABLE. THE COMPRESSION STRENGTH OF CDF SHOULD BE BETWEEN 75-150 PSI.
- 8. SAND BAGS MAY BE LEFT IN PLACE. BACKFILL AGAINST BAGS WITH SAND PIPE BEDDING PER PSE SPEC. 1275.1380.

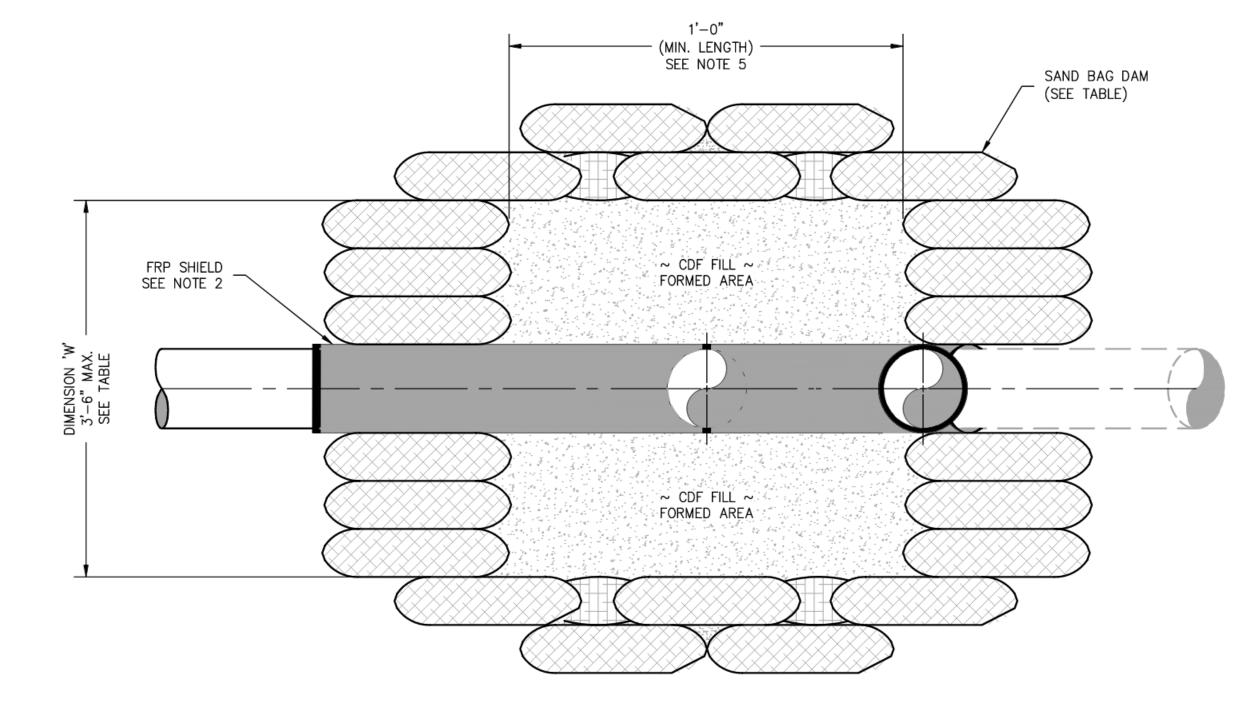


FOUNDATION PLAN VIEW

SCALE: NTS

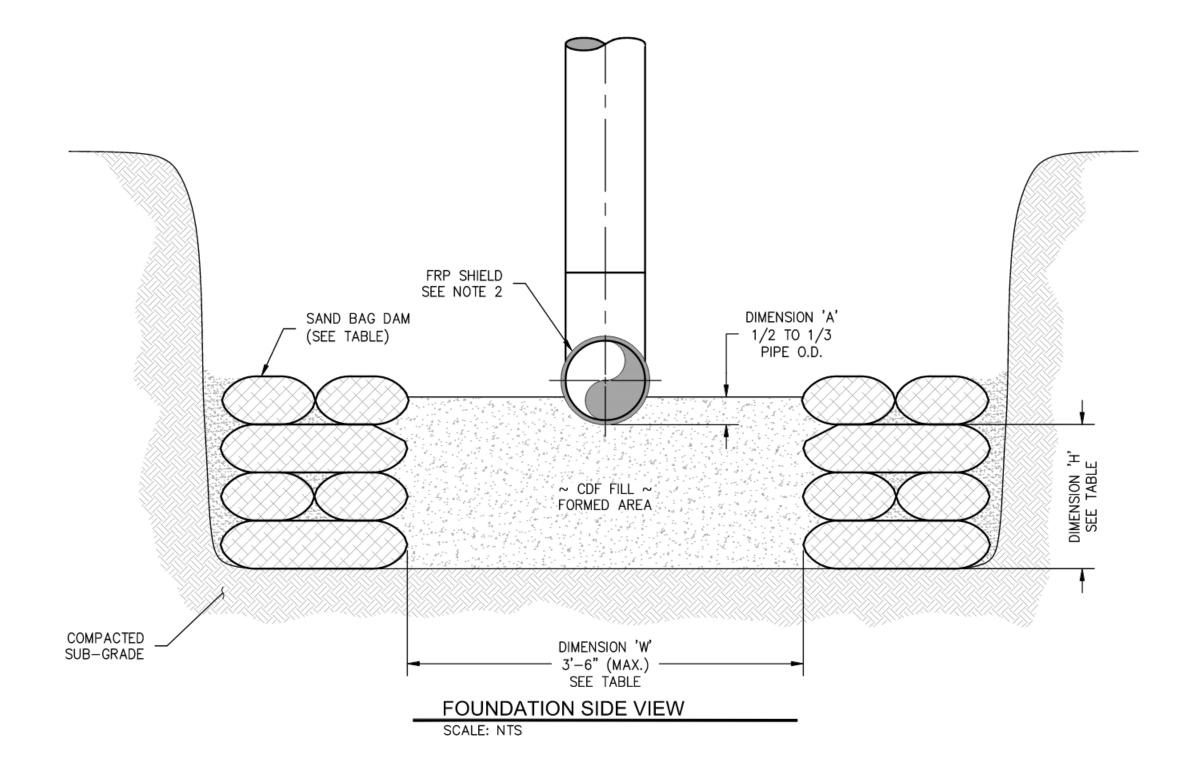

	FOUNDATION SIZE TABLE (H X W)										
FC	UNDATION		VERTICAL RISER PIPE SIZE								
L	SIZE	2" OR LESS	4"	4" 6" 8" 12" 16"				20"			
SIZE	2"	12" X 12"	N/A								
S	4"	12 X 12	12" X 12" N/A								
PIPE	6 "	10" V 15"		12" X 15"		13" X 18"		N/A			
	8"	12 /	(15	13 % 18		N/A					
ΤA	12"	12" X 21"		13" X 24"	16" X 24"		N/	A			
ő	16"	12" >	X 24"		16 X 24	20" X 33"					
HORIZONTAL	20"	12" >	〈 27"	13" X 27"			24" X	42"			
윈	24"	12" >	〈 30"	13" X 30"	17" X 30"	19" X 36"					

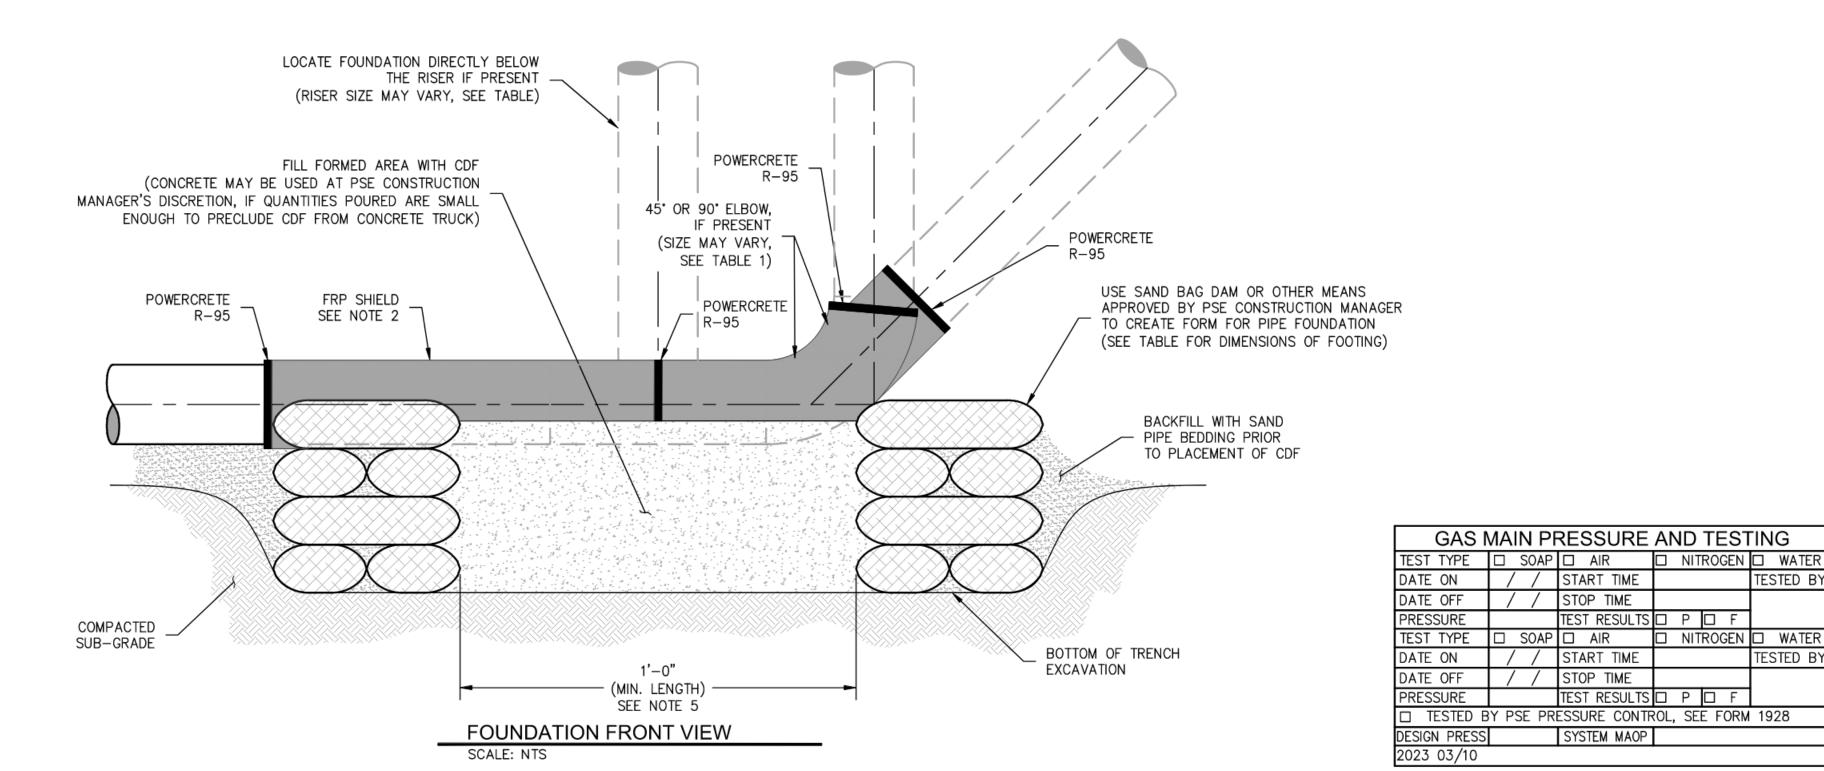

FITTER'S CHECKLIST (CHECK BOX TO CONFIRM COMPLETION) ☐ INSPECTED STEEL AND PE PIPE PER GOS 2450.1400 AND 2450.1500. ☐ REVIEWED AND COMPLIED WITH ALL CONSTRUCTION NOTES. \square RECORDED ALL REQUIRED INFORMATION ON THE AS-BUILT PER GOS 2500.1700. ☐ COMPLETED POST INSTALLATION INSPECTION PER GOS 2525.1200 AND 2525.2700. ☐ LEFT THE WORK AREA IN A CLEAN AND SAFE CONDITION. FOREMAN'S SIGNATURE: _____ FOREMAN'S NAME (PRINTED): _____

4680 06/11

ISSUED FOR CONSTRUCTION PER WO BY CKR CP ENG APP PM DATE DESCRIPTION **REVISIONS**

CALL (800) 424-5555 2 BUSINESS DAYS BEFORE YOU DIG

THIS SKETCH NOT TO BE RELIED UPON FOR EXACT LOCATION OF FACILITIES

TEST RESULTS P F

TEST RESULTS 🗆 P 🔲 F

SYSTEM MAOP

REAL ESTATE/EASEMENT N/A FUNCTION NAME

PROJECT MANAGER CONTACT INFO MATT FOSTER 253-303-9373 CELL PHONE matt.foster@pse.com EMAIL EMER SECTION GAS WK CTR

PGRPC012

PLAT MAP

324.014

PHONE PROJECT MGR M.FOSTER 253-303-9373 ENGINEER T.SAYAVONG 425-424-7828 DRAWN BY T.LY 425-424-6414 CHECKED BY J.MALM 425-424-6421 APPROVED BY J.EWING 425-424-7824 CP APP 253-234-6396 M.HAACK MAPPING

1/4 SECTION OP MAP NW-3-13-02W 324.014

PSE SOUND ENERGY

LEWIS

RS-2854 KENNICOTT RD & WALLACE RD CHEHALIS, WA


SAP ORDER NUMBER 109143773 DWG NUMBER 3D13-517

SCALE: AS NOTED

TESTED BY

TESTED BY

☐ NITROGEN ☐ WATER

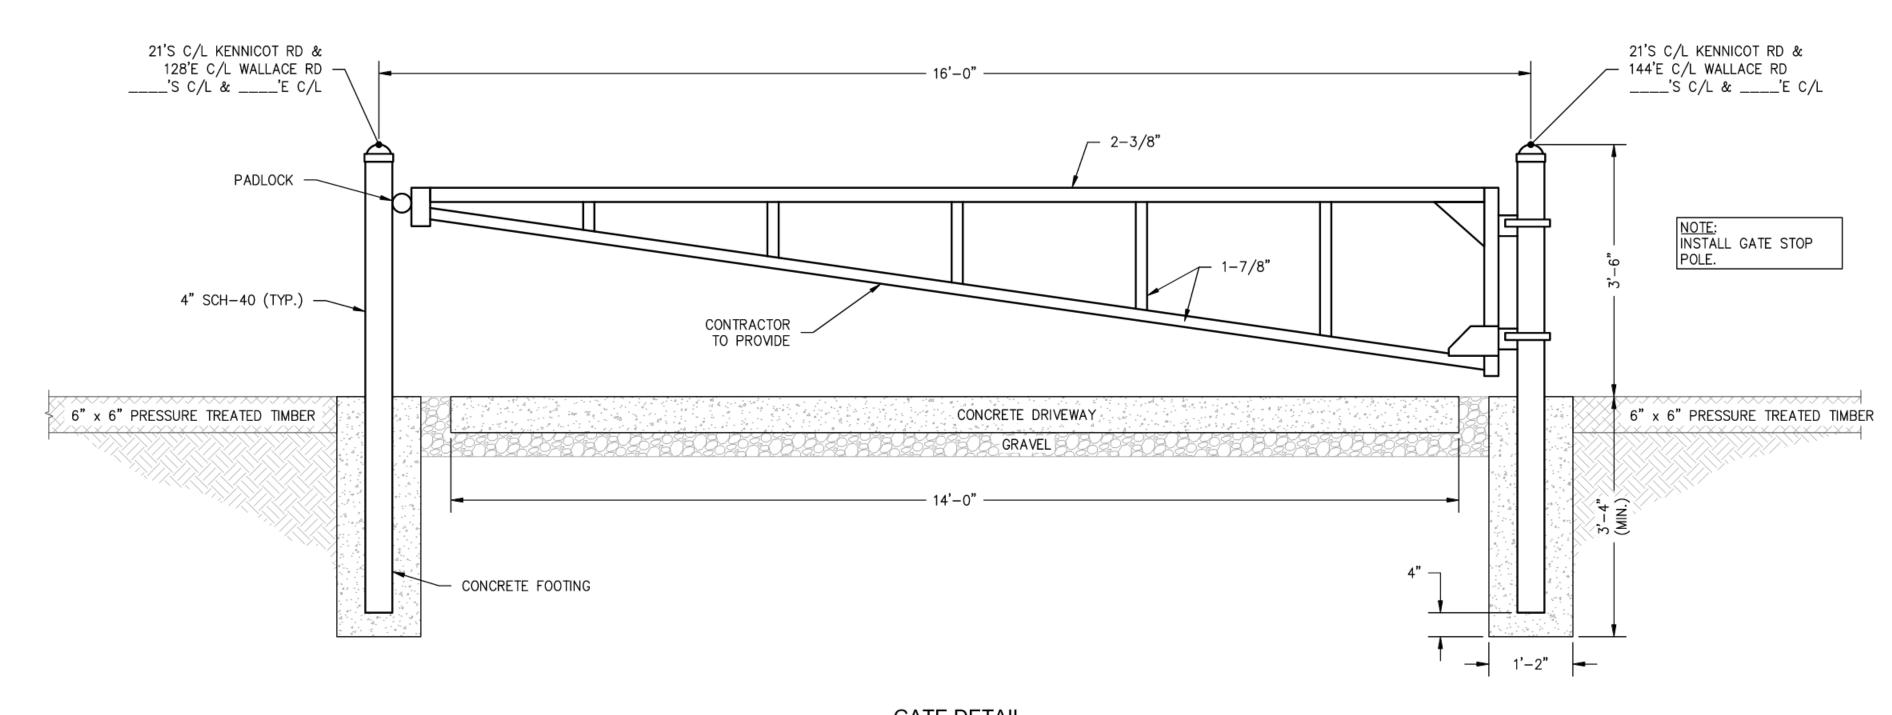

GATE DETAIL
- SINGLE SWING BARRIER GATE
SCALE: 3/4" = 1'-0"

SECOMA FENCE 1-7/8" CQ FRAME ONLY MODEL #015772

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\triangle	ISSUED FOR CONSTRUCTION PER WO 109143773	TL	On	MX	75	AJW	m.Z.	2023.10.30 15:17:50-07'00'
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	REVISIONS							

GAS I	MAIN PF	RESSURE	A۱	ND	TEST	ΓΙΝ	G
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DATE OFF	/ /	STOP TIME					
PRESSURE		TEST RESULTS		Р	□ F		
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DATE OFF	/ /	STOP TIME					
PRESSURE		TEST RESULTS		Р	□ F		
☐ TESTED B	Y PSE PR	ESSURE CONTR	ROL,	SE	E FORM	19	28
DESIGN PRESS		SYSTEM MAOP					
2023 03/10		_					

CALL (800) 424-5555 2 BUSINESS DAYS BEFORE YOU DIG

		THIS SKETCH	NOT TO BE RELIE	D UPON FOR E	XACT LOCATION OF	FACILITIES	
			REAL ESTATE/E	EASEMENT	PERMIT		
			N/A		N/A		
PROJECT MANA	GER CONTACT INFO	 	FUNCTION	NAME	PHONE	DATE	
MATT FOSTER			PROJECT MGR	M.FOSTER	253-303-9373		
253-3	03-9373 CELL PH	ONE	ENGINEER	T.SAYAVONG	425-424-7828		
matt.foster	©pse.com EMAIL		DRAWN BY	T.LY	425-424-6414		
			CHECKED BY	J.MALM	425-424-6421		
NTY	EMER SECTION	GAS WK CTR	APPROVED BY	J.EWING	425-424-7824		
S	350	PGRPC012	CP APP	M.HAACK	253-234-6396		

COUNTY
LEWIS
350
1/4 SECTION
NW-3-13-02W

PUGET

RS-2

COUNTY
EMER SECTION
GAS WK CTR
PGRPC012
PLAT MAP
324.014

RS-2

CENNICOTT DE


RS-2854 KENNICOTT RD & WALLACE RD CHEHALIS, WA

MAPPING

SAP ORDER NUMBER
109143773

DWG NUMBER
3D13-517

SCALE: 3/4" = 1'-0" 13/15

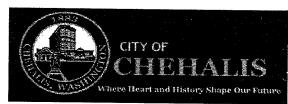

Return your conference application to Community Development Department


1321 S Market Blvd. Chehalis, WA 98532 (360) 345-2229


www.ci.chehalis.wa.us email: comdev@ci.chehalis.wa.us

JOB SITE ADDRESS:	PARCEL #:
APPLICANT/CONTACT PERSON: NAME: Shunah Dalcy ADDRESS: 1027 Joaquin St CITY/ST/ZIP: Unind, LA 91710 PHONE#: 909-2108-21028 EMAIL: Shanah BE Ogmail Com	CONTRACTOR / ENGINEER / SURVEYOR: COMPANY NAME: CONTACT NAME: ADDRESS: PHONE #: EMAIL: CONTRACTORS L&I #:
	Yes No No
Add 17 New Space	existing mobile home park
Verbal comments made during discovery are not binding. Only the codes. By signing below, I grant permission for City of Chehalis empand approval of this proposal and to conduct inspections related to Signature:	ployees to enter and remain on the property for the purpose of review this proposal.
1	2/12/24
Sharah Paley Marah Daley	Telephone #: 909-268-2628
J	
Office use only Received by:	Date Received:
Parcel #:	-
Permit #:	
Zoning:	
Flood Zone: Yes No	
Zone Classification:	



Vicinity Map for AC-24-008 for 1950 Kresky Ave NE

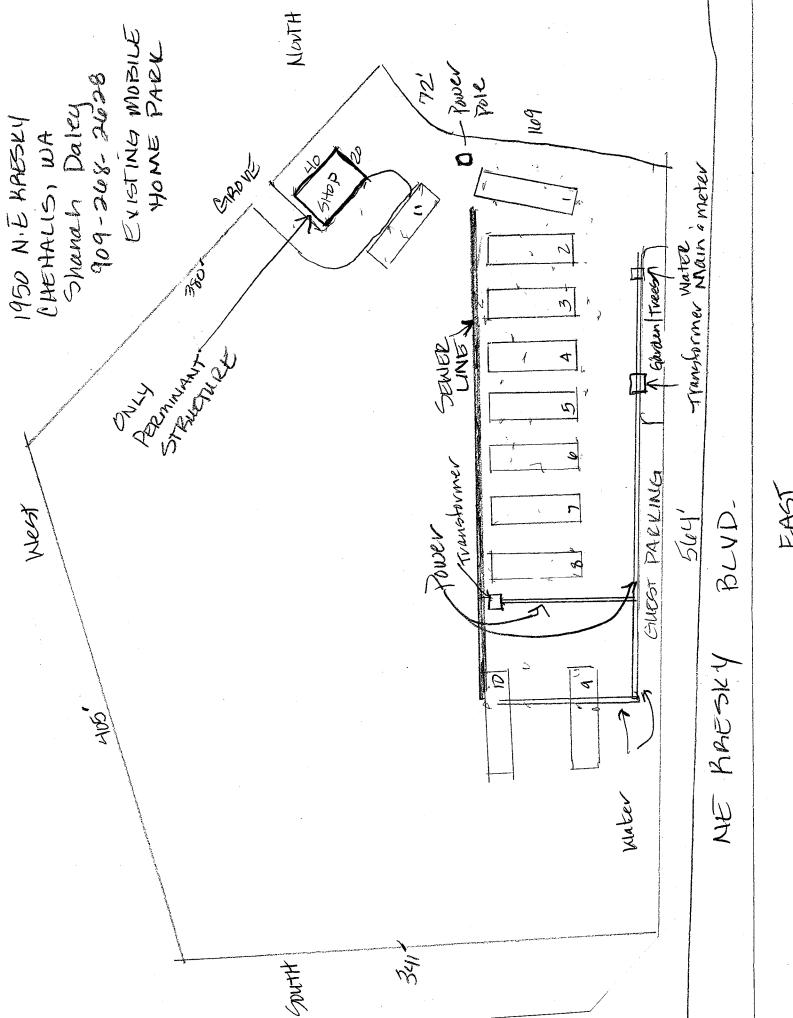

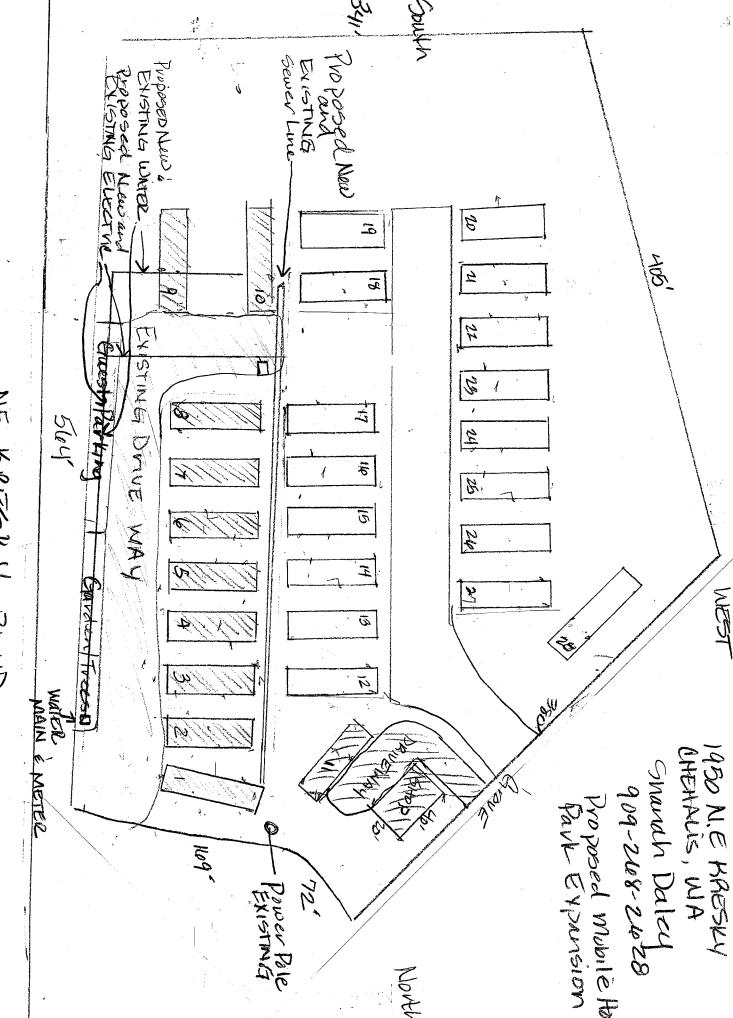

NE REDOTY BIND

EXOT



Return your conference application to Community Development Department

1321 S Market Blvd. Chehalis, WA 98532 (360) 345-2229

www.ci.chehalis.wa.us email: comdev@ci.chehalis.wa.us

IOR SITE ADDRESS. 841 NW Liberty Plaza PARCEL # 005780005000&005780003000

JOB SITE ADDRESS: OTT WW HIDETEY TIAZA	PARCEL #:005/80005000&005/80003000_
APPLICANT / CONTACT PERSON:	CONTRACTOR / ENGINEER / SURVEYOR:
NAME: Dan Mitzel	COMPANY NAME: R&B Engineering
ADDRESS: 1111 Cleveland Ave Suite 203	CONTACT NAME: Robert Balmelli
CITY/ST/ZIP: Mount vernon WA. 98273	ADDRESS: PO Box 923 Chehalis WA
PHONE#: 360-404-2090	PHONE #:_360-740-8919
EMAIL: danmitzel@mitzel.net	EMAIL: Robertb@rbengineers.com
	CONTRACTORS L&I #: MHCONHC941BC
Is the property owner the same as the contact person?	Yes No X
DETAILED PROJECT DESCRIPTION: We propose to	o build a 97 room extended stay hotel
on a site directly west of the Hol	iday Inn Express Hotel.The property
has approximately 400' of frontage	
primary access off of Prindle and	secondary access through the Liberty Pi
Signature:	<u>Date:</u>
Wan & Mitzel	02/06/2024
Name (print):	Telephone #:
Dan R. Mitzel	360-404-2090
Office use only	
Received by:	Date Received:
Parcel #:	
Permit #:	
Zaningu	
Zoning:	
Zoning: Flood Zone: Yes No	



DESIGN → **PERMIT** → **MANAGE**

February 7, 2024

Ron Buckholt
City of Chehalis Community Development
1321 S Market Blvd
Chehalis, WA 98532
rbuckholt@ci.chehalis.wa.us

Re: H3 Hilton Extended Stay Hotel – Applicant Conference Request and Narrative

RBE NO. 22025

Dear Ron:

Attached is an application for DRC Meeting request. The project is proposing a new 4 story, 50,932 sf, 97 room H3 Hilton Hotel at 841 NW Prindle Street. The project owners have received approval to complete a Boundary Line Adjustment with the adjacent parcel owner to expand parcel 005780005000. The property is zoned CG General Commercial and is an outright allowed use per the zoning code. The BLA will be submitted concurrently with the Land Use Package.

Parking:

The CG zone requires one stall per room for a total of 97 stalls. The current attached plan shows 108 new parking spaces for the project with 54 offsite parking stalls for the adjacent parcel owner.

H3 Hotel Site

Standard Parking Stalls 9'x20' = 38 stalls Standard Parking Stalls 9'x19' = 36 stalls Compact Stalls 9' x 18' = 9 stalls

ADA Stalls = 4 stalls – 3 Standard plus 1 Van Stall

EV Stalls = 10 stalls - 10% of Total

Prindle St. Parallel Stalls = 11 stalls

Total Parking Stalls H3 Hilton = 97 Onsite, 11 Offsite Stalls

Alta Forest Products

Offsite Parking Lot Stalls 9'x20' = 53 stalls – Alta Forest Products

Stormwater:

The Liberty Plaza Development was developed with a regional stormwater detention and treatment pond and conveyance design to allow all lots to connect to the existing pond. The stormwater facility was modeled using single event methodology and the wetpond was sized per the DOE method. We are asking for the City to allow this project to use the existing storm facility in its current state for this project. The original stormwater design accounted for 82% impervious surface coverage for the Liberty Plaza Development. With this new development we are at hard surface coverage of approximately 80%.

Critical Areas:

The Liberty Plaza Development Critical Area Report included buffer averaging along the existing onsite stream and associated wetlands. That final buffer line is included on the attached site plan. No additional wetland review

was deemed necessary for this project. Any increase in buffers due to critical area ordinance changes would stop at the limits of development and not impact the developed lot so the Liberty Plaza Development.

Traffic:

This project will utilize Prindle Street as the main access for the H3 Hilton, Chehalis project with connections to the Holiday Inn Express parking lot and gated access to the new Alta Forest Products parking lot. A traffic study has been completed that analyzed the area intersections. All intersections will operate at a level of Service B or above per the traffic analysis. That analysis will be submitted with the Land Use Application. The existing access to Main Street will be improved to provide better site distance and curb return.

Utilities:

The H3 Hilton, Chehalis hotel will utilize the water main in Prindle Street for domestic water service. The existing 8-inch gravity sewer main will be utilized for sewer connection. The old SSFM crossing the property has been abandoned and will be left in place. Easement vacation is pending with the City of Chehalis.

This project will also require re-location of the current domestic and irrigation meter services for Alta Forest Products located along Prindle Street. We propose to move them to the west property line. Communication lines and vaults will also need to be relocated and coordinated with those service providers.

Prindle Street Frontage:

Frontage improvements along Prindle include new curb, gutter and sidewalk along with street lighting. We are also proposing parallel 7-ft wide on-street parking along the local access roadway.

Main Street Driveway Access:

The existing Liberty Plaza access to Main Street will be improved to provide better site distance and added curb return to the west.

We look forward to discussing this project with you.

Sincerely,

Robert Balmelli PE Principal

cc: Project file

Enclosure: Preliminary Site Plan

City Applicant Conference Form

